					DEPARTME		-				AMENE	FO DED REPOR	RM 3	
		AF	PLICATION	FOR P	PERMIT TO DRILL	-				1. WELL NAME and NUMBER GMBU M-29-8-17				
2. TYPE O	F WORK	DRILL NEW WELL	REENTE	R P&A	WELL DEEPE	EN WELL ()			3. FIELD OR WILDCAT	T MONUMEN	NT BUTTE		
4. TYPE O	F WELL				Methane Well: NO					5. UNIT or COMMUNIT	FIZATION GMBU (ENT NAM	1E
6. NAME (F OPERATOR				TION COMPANY					7. OPERATOR PHONE				
8. ADDRESS OF OPERATOR Rt 3 Box 3630 , Myton, UT, 84052										9. OPERATOR E-MAIL	-	ewfield.co	m	
	AL LEASE NUM		ТК 0 Дол 000		11. MINERAL OWNE	-			_	12. SURFACE OWNER	SHIP			_
		UTU-76956 OWNER (if box 12	= 'fee'\		FEDERAL (III) II	NDIAN () STATE (_) FEE(<u> </u>	FEDERAL INI	DIAN ()	(if box 12	~	EE ()
13. IVAINE	OI GOINI AGE	OWNER (II BOX 12	_ 100)							14. GORT AGE GWILE	VI IIONE	(II DOX 12	- 100)	
15. ADDR	ESS OF SURFA	CE OWNER (if box	12 = 'fee')							16. SURFACE OWNER	R E-MAIL	(if box 12	= 'fee')	
	N ALLOTTEE OI = 'INDIAN')	R TRIBE NAME			18. INTEND TO COM MULTIPLE FORMAT		PRODUCTION	N FROM		19. SLANT				
(20% 12	,				YES (Submi	it Comming	ling Applicati	ion) NO [<u> </u>	VERTICAL DIF	RECTIONA	AL (B)	IORIZONT	TAL 🔵
20. LOC	TION OF WELL			FOC	OTAGES	QT	r-qtr	SECT	TION	TOWNSHIP	R/	ANGE	МЕ	ERIDIAN
LOCATIO	N AT SURFACE		19	94 FNL	_ 1959 FEL		SWNE	29	9	8.0 S	17	7.0 E		S
Top of U	ppermost Prod	ucing Zone	24	16 FNL	_ 2426 FEL		SWNE 29		8.0 S	17	7.0 E		S	
At Total	Depth		25	13 FSL	2442 FWL		NESW	29	9	8.0 S 17.0		7.0 E		S
21. COUN	TY	DUCHESNE		1	22. DISTANCE TO NI		EASE LINE (F 142	eet)		23. NUMBER OF ACRE	ES IN DRI 2		IT	
					25. DISTANCE TO NI (Applied For Drillin	ng or Comp		POOL		26. PROPOSED DEPTI		TVD: 655	0	
27. ELEV	TION - GROUN	5283		1	28. BOND NUMBER		29. SOURCE OF DRILLING WATER / WATER RIGHTS APPROVAL NUMBER IF APPLICABLE 437478				LE			
					Hole, Casir	ng, and C	ement Info	ormation						
String	Hole Size	Casing Size	Length	Wei	ght Grade &	Thread	Max Mu	d Wt.	Cement		Sacks	Yield	Weight	
Surf	12.25	8.625	0 - 300	24	.0 J-55 S	T&C	8.3	3	Class G			138	1.17	15.8
Prod	7.875	5.5	0 - 6674	15	.5 J-55 L	.T&C	8.3	3	Premium Lite High Strength			323	3.26	11.0
										50/50 Poz			1.24	14.3
						ATTACH	IMENTS							
	VER	IFY THE FOLLO	WING ARE A	TTAC	HED IN ACCORDA	ANCE WIT	TH THE UT	AH OIL AN	ND GAS	CONSERVATION G	ENERAI	L RULES		
✓ w	ELL PLAT OR M	AP PREPARED BY	LICENSED SUR	VEYOR	OR ENGINEER		⊯ com	IPLETE DRII	LLING P	LAN				
AF	FIDAVIT OF STA	TUS OF SURFACE	OWNER AGRE	EMENT	(IF FEE SURFACE)		FORM	M 5. IF OPER	RATOR I	S OTHER THAN THE LE	EASE OW	NER		
DIRECTIONAL SURVEY PLAN (IF DIRECTIONALLY OR HORIZONTALLY DRILLED)								OGRAPHICA	AL MAP					
NAME Heather Calder TITLE Production Technician										PHONE 435 646-493	6			
SIGNATURE DATE 06/24/2014										EMAIL hcalder@newfi	eld.com			
	BER ASSIGNED 013530070	0000			APPROVAL				B	00.6ylll				
i .				Permit Manager										

NEWFIELD PRODUCTION COMPANY GMBU M-29-8-17 AT SURFACE: SW/NE SECTION 29, T8S R17E DUCHESNE COUNTY, UTAH

TEN POINT DRILLING PROGRAM

1. **GEOLOGIC SURFACE FORMATION:**

Uinta formation of Upper Eocene Age

2. <u>ESTIMATED TOPS OF IMPORTANT GEOLOGIC MARKERS:</u>

Uinta 0' - 1,795' Green River 1,795' Wasatch 6,455'

Proposed TD 6,674'(MD) 6,550' (TVD)

3. <u>ESTIMATED DEPTHS OF ANTICIPATED WATER, OIL, GAS OR MINERALS:</u>

Green River Formation (Oil) 1,795' – 6,455'

Fresh water may be encountered in the Uinta Formation, but would not be expected below about 350'. All water shows and water bearing geologic units shall be reported to the geologic and engineering staff of the Vernal Office prior to running the next string of casing or before plugging orders are requested. All water shows must be reported within one (1) business day after being encountered.

All usable (<10,000 PPM TDS) water and prospectively valuable minerals (as described by BLM at onsite) encountered during drilling will be recorded by depth and adequately protected. This information shall be reported to the Vernal Office.

Detected water flows shall be sampled, analyzed, and reported to the geologic & engineering staff of the Vernal Office. The office may request additional water samples for further analysis. Usage of the State of Utah form *Report of Water Encountered* is acceptable, but not required.

The following information is requested for water shows and samples where applicable:

Location & Sampled Interval Date Sampled Flow Rate Temperature

Hardness pH

 $\begin{array}{lll} \text{Water Classification (State of Utah)} & \text{Dissolved Calcium (Ca) (mg/l)} \\ \text{Dissolved Iron (Fe) (ug/l)} & \text{Dissolved Sodium (Na) (mg/l)} \\ \text{Dissolved Magnesium (Mg) (mg/l)} & \text{Dissolved Carbonate (CO}_3) (mg/l)} \\ \text{Dissolved Bicarbonate (NaHCO}_3) (mg/l)} & \text{Dissolved Chloride (Cl) (mg/l)} \\ \text{Dissolved Sulfate (SO}_4) (mg/l)} & \text{Dissolved Total Solids (TDS) (mg/l)} \\ \end{array}$

RECEIVED: June 24, 2014

4. PROPOSED CASING PROGRAM

a. Casing Design: GMBU M-29-8-17

Size	Interval		Weight	Grade	Coupling	Design Factors			
Size	Тор	Bottom	weigni	Grade	Coupling	Burst	Collapse	Tension	
Surface casing	0'	300'	24.0	J-55	STC	2,950	1,370	244,000	
8-5/8"	U	300	24.0	3-33	310	17.53	14.35	33.89	
Prod casing	01	0.074	45.5		1.70	4,810	4,040	217,000	
5-1/2"	0'	6,674'	15.5	J-55	LTC	2.27	1.90	2.10	

Assumptions:

- 1) Surface casing max anticipated surface press (MASP) = Frac gradient gas gradient
- 2) Prod casing MASP (production mode) = Pore pressure gas gradient
- 3) All collapse calculations assume fully evacuated casing w/ gas gradient
- 4) All tension calculations assume air weight

Frac gradient at surface casing shoe = 13.0 ppg
Pore pressure at surface casing shoe = 8.33 ppg
Pore pressure at prod casing shoe = 8.33 ppg
Gas gradient = 0.115 psi/ft

All casing shall be new or, if used, inspected and tested. Used casing shall meet or exceed API standards for new casing.

All casing strings shall have a minimum of 1 (one) centralizer on each of the bottom three (3) joints.

b. Cementing Design: GMBU M-29-8-17

Job	Fill	Description	Sacks ft ³	OH Excess*	Weight (ppg)	Yield (ft³/sk)	
Surface casing	300'	Class G w/ 2% CaCl	138 161	30%	15.8	1.17	
Prod casing	4,674'	Prem Lite II w/ 10% gel + 3%	323	30%	11.0	3.26	
Lead	4,074	KCI	1053	3070	11.0		
Prod casing	2,000'	50/50 Poz w/ 2% gel + 3%	363	30%	14.3	1.24	
Tail	2,000	KCI	451	3076	14.3	1.24	

^{*}Actual volume pumped will be 15% over the caliper log

- Compressive strength of lead cement: 1800 psi @ 24 hours, 2250 psi @ 72 hours
- Compressive strength of tail cement: 2500 psi @ 24 hours

Hole Sizes: A 12-1/4" hole will be drilled for the 8-5/8" surface casing. A 7-7/8" hole will be drilled for the 5-1/2" production casing.

The 8-5/8" surface casing shall in all cases be cemented back to surface. In the event that during the primary surface cementing operation the cement does not circulate to surface, or if the cement level should fall back more than 8 feet from surface, then a remedial surface cementing operation shall be performed to insure adequate isolation and stabilization of the surface casing.

5. <u>MINIMUM SPECIFICATIONS FOR PRESSURE CONTROL</u>:

The operator's minimum specifications for pressure control equipment are as follows:

An 8" Double Ram Hydraulic unit with a closing unit will be utilized. Function test of BOP's will be check daily.

Refer to **Exhibit C** for a diagram of BOP equipment that will be used on this well.

6. TYPE AND CHARACTERISTICS OF THE PROPOSED CIRCULATION MUDS:

From surface to ±300 feet will be drilled with an air/mist system. The air rig is equipped with a 6 ½" blooie line that is straight run and securely anchored. The blooie line is used with a discharge less than 100 ft from the wellbore in order to minimize the well pad size. The blooie line is not equipped with an automatic igniter or continuous pilot light and the compressor is located less than 100 ft from the well bore due to the low possibility of combustion with the air dust mixture. The trailer mounted compressor (capacity of 2000 CFM) has a safety shut-off valve which is located 15 feet from the air rig. A truck with 70 bbls of water is on stand by to be used as kill fluid, if necessary. From about ±300 feet to TD, a fresh water system will be utilized. Clay inhibition and hole stability will be achieved with a KCl substitute additive. This additive will be identified in the APD and reviewed to determine if the reserve pit shall be lined. This fresh water system will typically contain Total Dissolved Solids (TDS) of less than 3000 PPM. Anticipated mud weight is 8.4 lbs/gal. If necessary to control formation fluids or pressure, the system will be weighted with the addition of bentonite gel, and if pressure conditions warrant, with barite

No chromate additives will be used in the mud system on Federal and/or Indian lands without prior BLM approval to ensure adequate protection of fresh aquifers.

No chemicals subject to reporting under SARA Title III in an amount equal to or greater than 10,000 pounds will be used, produced, stored, transported, or disposed of annually in association with the drilling, testing, or completing of this well. Furthermore, no extremely hazardous substances, as defined in 40 CFR 355, in threshold planning quantities, will be used, produced, stored, transported, or disposed of in association with the drilling, testing, or completing of this well.

Hazardous substances specifically listed by the EPA as a hazardous waste or demonstrating a characteristic of a hazardous waste will not be used in drilling, testing, or completion operations.

Newfield Production will **visually** monitor pit levels and flow from the well during drilling operations.

7. <u>AUXILIARY SAFETY EQUIPMENT TO BE USED:</u>

Auxiliary safety equipment will be a Kelly Cock, bit float, and a TIW valve with drill pipe threads.

8. <u>TESTING, LOGGING AND CORING PROGRAMS</u>:

The logging program will consist of a Dual Induction, Gamma Ray and Caliper log from TD to base of surface casing @ 300' +/-, and a Compensated Neutron-Formation Density Log from TD to 3500' +-. A cement bond log will be run from PBTD to cement top. No drill stem testing or coring is planned for this well.

9. **ANTICIPATED ABNORMAL PRESSURE OR TEMPERATURE:**


No abnormal temperatures or pressures are anticipated. No hydrogen sulfide has been encountered or is known to exist from previous drilling in the area at this depth. Maximum anticipated

bottomhole pressure will approximately equal total depth in feet multiplied by a $0.433~\mathrm{psi/foot}$ gradient.


10. <u>ANTICIPATED STARTING DATE AND DURATION OF THE OPERATIONS:</u>

It is anticipated that the drilling operations will commence the fourth quarter of 2014, and take approximately seven (7) days from spud to rig release.

RECEIVED: June 24, 2014

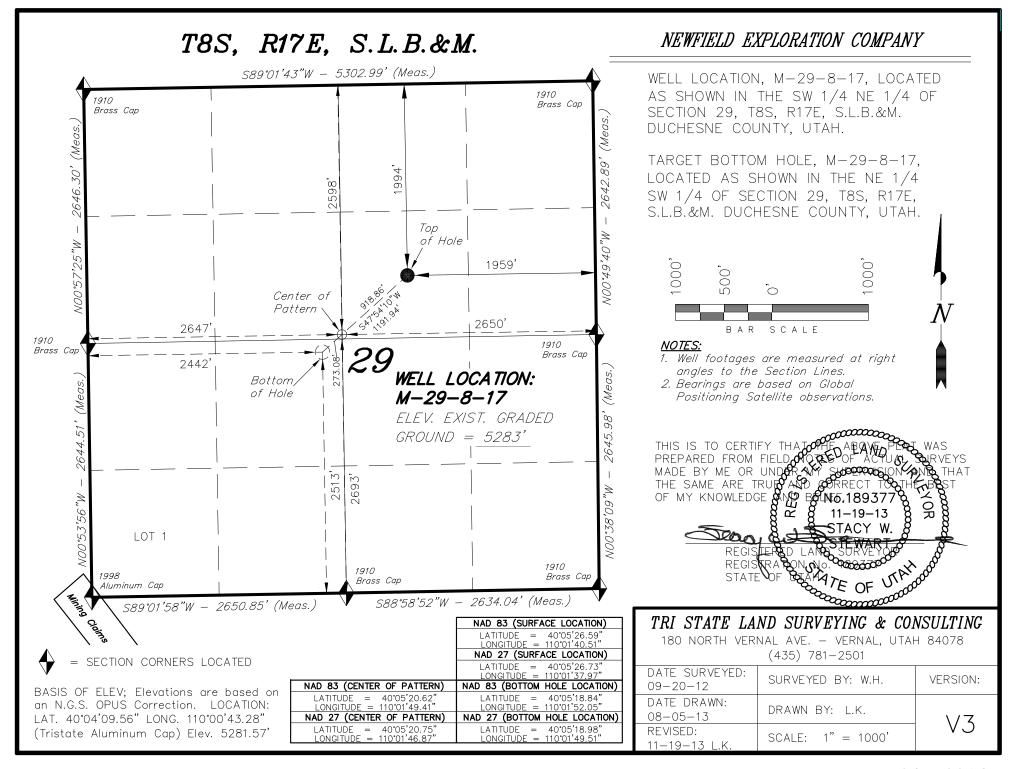

API Well Number: 43013530070000 North **Access Road Map** Myton Flattop Butte Windy Ridge CANAL Gaging **MYTON** (# 1.7 mi.) Bench Radio Myton DUCHESNE UNIVAH O VALLEY CorralC PLEASANT Valley Existing 10-29-8-17 Pad Proposed Wells: M-29-8-17, RESERVATION L-29-8-17 and 7-29-8-17 See Topo "B" ± 1.3 mi. ametre Mine 136 Castle USUM 234 Legend Existing Road

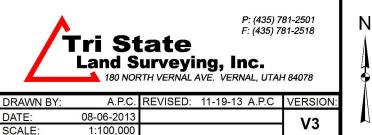


NEWFIELD EXPLORATION COMPANY

Existing 10-29-8-17 Pad
Proposed Wells: M-29-8-17, L-29-8-17 and 7-29-8-17
Sec. 29, T8S, R17E, S.L.B.&M.
Duchesne County, UT.

TOPOGRAPHIC MAP



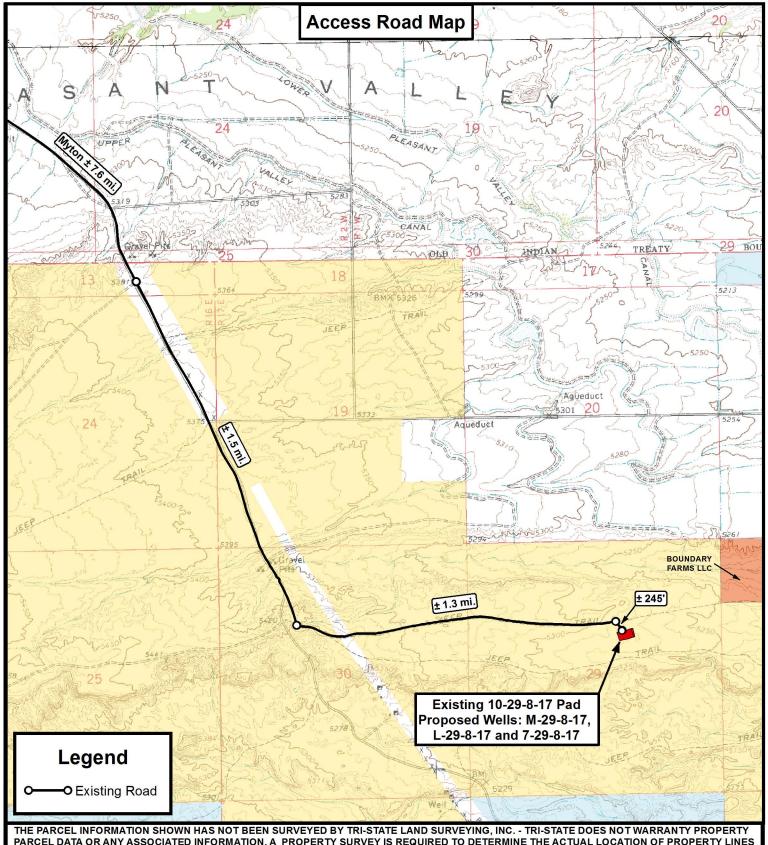

PARCEL DATA OR ANY ASSOCIATED INFORMATION. A PROPERTY SURVEY IS REQUIRED TO DETERMINE THE ACTUAL LOCATION OF PROPERTY LINES AND SHOW ACCURATE DISTANCES ACROSS PARCELS.

Ν



P: (435) 781-2501 F: (435) 781-2518

180 NORTH VERNAL AVE. VERNAL, UTAH 84078


DRAWN BY:	A.P.C.	REVISED:	11-19-13 A.P.C	VERSION :
DATE:	08-06-2013			V3
SCALE:	1 " = 2,000 '			V3

NEWFIELD EXPLORATION COMPANY


Existing 10-29-8-17 Pad Proposed Wells: M-29-8-17, L-29-8-17 and 7-29-8-17 Sec. 29, T8S, R17E, S.L.B.&M. **Duchesne County, UT.**

TOPOGRAPHIC MAP



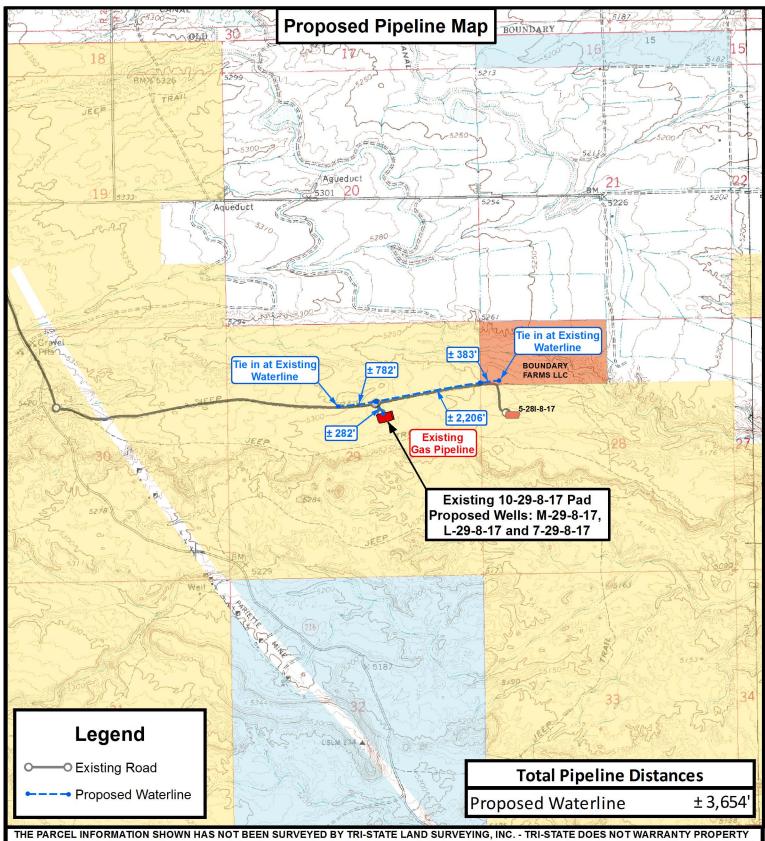

THE PARCEL INFORMATION SHOWN HAS NOT BEEN SURVEYED BY TRI-STATE LAND SURVEYING, INC. - TRI-STATE DOES NOT WARRANTY PROPERTY PARCEL DATA OR ANY ASSOCIATED INFORMATION. A PROPERTY SURVEY IS REQUIRED TO DETERMINE THE ACTUAL LOCATION OF PROPERTY LINES AND SHOW ACCURATE DISTANCES ACROSS PARCELS.

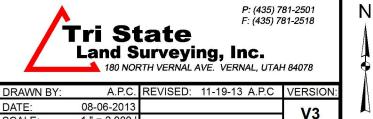

SCALE


1 " = 2,000

NEWFIELD EXPLORATION COMPANY


Existing 10-29-8-17 Pad
Proposed Wells: M-29-8-17, L-29-8-17 and 7-29-8-17
Sec. 29, T8S, R17E, S.L.B.&M.
Duchesne County, UT.

TOPOGRAPHIC MAP

SHEET

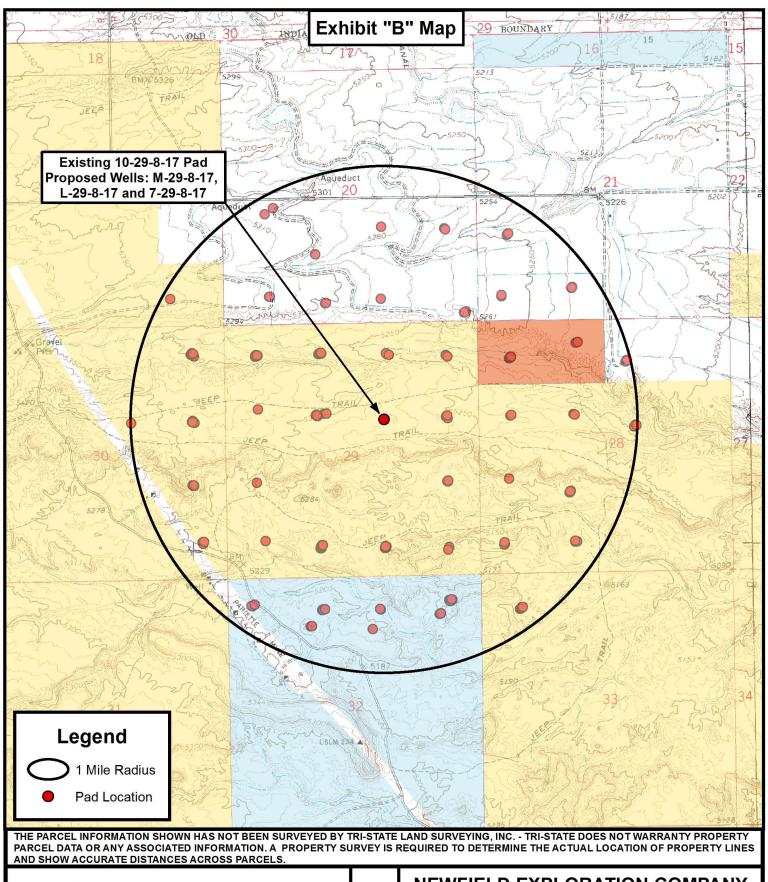

N

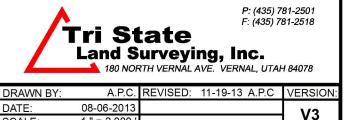

SCALE

1 " = 2,000

NEWFIELD EXPLORATION COMPANY

Existing 10-29-8-17 Pad Proposed Wells: M-29-8-17, L-29-8-17 and 7-29-8-17 Sec. 29, T8S, R17E, S.L.B.&M. Duchesne County, UT.

TOPOGRAPHIC MAP



Coordinate Report									
Well Number	Feature Type	Latitude (NAD 83) (DMS)	Longitude (NAD 83) (DMS)						
10-29-8-17	Surface Hole	40° 05′ 26.41″ N	110° 01' 40.65" W						
M-29-8-17	Surface Hole	40° 05' 26.59" N	110° 01' 40.51" W						
L-29-8-17	Surface Hole	40° 05′ 26.77″ N	110° 01' 40.37" W						
7-29-8-17	Surface Hole	40° 05′ 26.95″ N	110° 01' 40.23" W						
M-29-8-17	Center of Pattern	40° 05' 20.62" N	110° 01' 49.41" W						
L-29-8-17	Center of Pattern	40° 05' 20.11" N	110° 01' 32.82" W						
M-29-8-17	Bottom of Hole	40° 05' 18.84" N	110° 01' 52.05" W						
L-29-8-17	Bottom of Hole	40° 05' 18.14" N	110° 01' 30.58" W						
Well Number	Feature Type	Latitude (NAD 83) (DD)	Longitude (NAD 83) (DD)						
10-29-8-17	Surface Hole	40.090669	110.027958						
M-29-8-17	Surface Hole	40.090719	110.027919						
L-29-8-17	Surface Hole	40.090769	110.027880						
7-29-8-17	Surface Hole	40.090819	110.027841						
M-29-8-17	Center of Pattern	40.089060	110.030391						
L-29-8-17	Center of Pattern	40.088919	110.025782						
M-29-8-17	Bottom of Hole	40.088567	110.031126						
L-29-8-17	Bottom of Hole	40.088371	110.025161						
Well Number	Feature Type	Northing (NAD 83) (UTM Meters)	Longitude (NAD 83) (UTM Meters)						
10-29-8-17	Surface Hole	4438273.419	582864.029						
M-29-8-17	Surface Hole	4438278.993	582867.298						
L-29-8-17	Surface Hole	4438284.567	582870.567						
7-29-8-17	Surface Hole	4438290.142	582873.836						
M-29-8-17	Center of Pattern	4438092.497	582658.570						
L-29-8-17	Center of Pattern	4438081.166	583051.640						
M-29-8-17	Bottom of Hole	4438037.071	582596.537						
L-29-8-17	Bottom of Hole	4438020.896	583105.294						
Well Number	Feature Type	Latitude (NAD 27) (DMS)	Longitude (NAD 27) (DMS)						
10-29-8-17	Surface Hole	40° 05' 26.55" N	110° 01' 38.11" W						
M-29-8-17	Surface Hole	40° 05' 26.73" N	110° 01' 37.97" W						
L-29-8-17	Surface Hole	40° 05' 26.91" N	110° 01' 37.83" W						
7-29-8-17	Surface Hole	40° 05' 27.09" N	110° 01' 37.69" W						
M-29-8-17	Center of Pattern	40° 05′ 20.75″ N	110° 01' 46.87" W						
L-29-8-17	Center of Pattern	40° 05' 20.25" N	110° 01' 30.28" W						
M-29-8-17	Bottom of Hole	40° 05′ 18.98″ N	110° 01' 49.51" W						
L-29-8-17	Bottom of Hole	40° 05' 18.27" N	110° 01' 28.04" W						
L-23-0-11	DOTTON OF LIGHT	70 00 10.27 N	110 01 20.04 VV						



VERSION:

P: (435) 781-2501 F: (435) 781-2518

NEWFIELD EXPLORATION COMPANY

Existing 10-29-8-17 Pad Proposed Wells: M-29-8-17, L-29-8-17 and 7-29-8-17 Sec. 29, T8S, R17E, S.L.B.&M. **Duchesne County, UT.**

A.P.C. REVISED: 11-19-13 A.P.C. DRAWN BY: DATE: 08-06-2013

COORDINATE REPORT

SHEET

	Coordina	ate Report	
Well Number	Feature Type	Latitude (NAD 27) (DD)	Longitude (NAD 27) (DD)
10-29-8-17	Surface Hole	40.090708	110.027253
M-29-8-17	Surface Hole	40.090757	110.027214
L-29-8-17	Surface Hole	40.090807	110.027175
7-29-8-17	Surface Hole	40.090857	110.027136
M-29-8-17	Center of Pattern	40.089098	110.029686
L-29-8-17	Center of Pattern	40.088957	110.025077
M-29-8-17	Bottom of Hole	40.088605	110.030421
L-29-8-17	Bottom of Hole	40.088409	110.024456
Well Number	Feature Type	Northing (NAD 27) (UTM Meters)	Longitude (NAD 27) (UTM Mete
10-29-8-17	Surface Hole	4438068.095	582926.279
M-29-8-17	Surface Hole	4438073.669	582929.547
L-29-8-17	Surface Hole	4438079.244	582932.816
7-29-8-17	Surface Hole	4438084.818	582936.085
M-29-8-17	Center of Pattern	4437887.173	582720.820
L-29-8-17	Center of Pattern	4437875.843	583113.892
M-29-8-17	Bottom of Hole	4437831.748	582658.787
L-29-8-17	Bottom of Hole	4437815.572	583167.548
^Tri Stat	P: (435) 781-2501 F: (435) 781-2518	NEWFIELD EXPLO	RATION COMPANY



Proposed Wells: M-29-8-17, L-29-8-17 and 7-29-8-17 Sec. 29, T8S, R17E, S.L.B.&M. **Duchesne County, UT.**

DRAWN BY: A.P.C. REVISED: 11-19-13 A.P.C. DATE: 08-06-2013 VERSION:

COORDINATE REPORT

SHEET



NEWFIELD EXPLORATION

USGS Myton SW (UT) SECTION 29 T8S, R17E M-29-8-17

Wellbore #1

Plan: Design #1

Standard Planning Report

05 August, 2013





Payzone Directional

Planning Report



Database: EDM 2003.21 Single User Db Company: NEWFIELD EXPLORATION Project: USGS Myton SW (UT) Site: SECTION 29 T8S, R17E

 Well:
 M-29-8-17

 Wellbore:
 Wellbore #1

 Design:
 Design #1

Local Co-ordinate Reference:

TVD Reference:
MD Reference:
North Reference:

Survey Calculation Method:

Well M-29-8-17

M-29-8-17 @ 5293.0ft (Original Well Elev) M-29-8-17 @ 5293.0ft (Original Well Elev)

Crid

Minimum Curvature

Project USGS Myton SW (UT), DUCHESNE COUNTY, UT, USA

Map System: US State Plane 1983

Geo Datum: North American Datum 1983

Map Zone: Utah Central Zone

System Datum: Mean Sea Level

Site SECTION 29 T8S, R17E, T8S R17E

7,204,529.47 ft Northing: Latitude: 40° 5' 20.491 N Site Position: Lat/Long Easting: 2,051,571.00 ft 110° 1' 49.208 W From: Longitude: **Position Uncertainty:** 0.0 ft Slot Radius: **Grid Convergence:** 0.94

Well M-29-8-17, SHL LAT: 40 05 26.59, LONG: -110 01 40.51

 Well Position
 +N/-S
 628.1 ft
 Northing:
 7,205,157.61 ft
 Latitude:
 40° 5' 26.590 N

 +E/-W
 665.7 ft
 Easting:
 2,052,236.71 ft
 Longitude:
 110° 1' 40.510 W

Position Uncertainty 0.0 ft Wellhead Elevation: 5,293.0 ft Ground Level: 5,283.0 ft

Wellbore	Wellbore #1				
Magnetics	Model Name	Sample Date	Declination (°)	Dip Angle (°)	Field Strength (nT)
	IGRF2010	8/5/2013	11.03	65.79	52,090

Design	Design #1					
Audit Notes:						
Version:		Phase:	PROTOTYPE	Tie On Depth:	0.0	
Vertical Section:		Depth From (TVD) (ft)	+N/-S (ft)	+E/-W (ft)	Direction (°)	
		0.0	0.0	0.0	227.90	

Plan Sections										
Measured Depth (ft)	Inclination (°)	Azimuth (°)	Vertical Depth (ft)	+N/-S (ft)	+E/-W (ft)	Dogleg Rate (°/100ft)	Build Rate (°/100ft)	Turn Rate (°/100ft)	TFO (°)	Target
0.0	0.00	0.00	0.0	0.0	0.0	0.00	0.00	0.00	0.00	
600.0	0.00	0.00	600.0	0.0	0.0	0.00	0.00	0.00	0.00	
1,408.9	12.13	227.90	1,402.8	-57.2	-63.3	1.50	1.50	0.00	227.90	
5,374.6	12.13	227.90	5,280.0	-616.0	-681.8	0.00	0.00	0.00	0.00	M-29-8-17 TGT
6,673.6	12.13	227.90	6,550.0	-799.1	-884.4	0.00	0.00	0.00	0.00	

RECEIVED: June 24, 2014



Payzone Directional

Planning Report



Database: EDM 2003.21 Single User Db Company: NEWFIELD EXPLORATION Project: USGS Myton SW (UT) Site: SECTION 29 T8S, R17E

 Well:
 M-29-8-17

 Wellbore:
 Wellbore #1

 Design:
 Design #1

Local Co-ordinate Reference:

TVD Reference:
MD Reference:
North Reference:

Survey Calculation Method:

Well M-29-8-17

M-29-8-17 @ 5293.0ft (Original Well Elev) M-29-8-17 @ 5293.0ft (Original Well Elev)

Grid

Minimum Curvature

Design:	Design #1								
Planned Survey									
Measured Depth (ft)	Inclination (°)	Azimuth (°)	Vertical Depth (ft)	+N/-S (ft)	+E/-W (ft)	Vertical Section (ft)	Dogleg Rate (°/100ft)	Build Rate (°/100ft)	Turn Rate (°/100ft)
0.0	0.00	0.00	0.0	0.0	0.0	0.0	0.00	0.00	0.00
100.0	0.00	0.00	100.0	0.0	0.0	0.0	0.00	0.00	0.00
200.0	0.00	0.00	200.0	0.0	0.0	0.0	0.00	0.00	0.00
300.0	0.00	0.00	300.0	0.0	0.0	0.0	0.00	0.00	0.00
400.0	0.00	0.00	400.0	0.0	0.0	0.0	0.00	0.00	0.00
500.0	0.00	0.00	500.0	0.0	0.0	0.0	0.00	0.00	0.00
600.0	0.00	0.00	600.0	0.0	0.0	0.0	0.00	0.00	0.00
700.0	1.50	227.90	700.0	-0.9	-1.0	1.3	1.50	1.50	0.00
800.0	3.00	227.90	799.9	-3.5	-3.9	5.2	1.50	1.50	0.00
900.0	4.50	227.90	899.7	-7.9	-8.7	11.8	1.50	1.50	0.00
1,000.0	6.00	227.90	999.3	-14.0	-15.5	20.9	1.50	1.50	0.00
1,100.0	7.50	227.90	1,098.6	-21.9	-24.2	32.7	1.50	1.50	0.00
1,200.0	9.00	227.90	1,197.5	-31.5	-34.9	47.0	1.50	1.50	0.00
1,300.0	10.50	227.90	1,296.1	-42.9	-47.5	64.0	1.50	1.50	0.00
1,408.9	12.13	227.90	1,402.8	-57.2	-63.3	85.3	1.50	1.50	0.00
1,500.0	12.13	227.90	1.491.9	-70.0	-77.5	104.5	0.00	0.00	0.00
1,600.0	12.13	227.90	1,589.7	-84.1	-93.1	125.5	0.00	0.00	0.00
1,700.0	12.13	227.90	1,687.5	-98.2	-108.7	146.5	0.00	0.00	0.00
1,800.0	12.13	227.90	1,785.2	-112.3	-124.3	167.5	0.00	0.00	0.00
1,900.0	12.13	227.90	1,883.0	-126.4	-139.9	188.6	0.00	0.00	0.00
2,000.0	12.13	227.90	1.980.8	-140.5	-155.5	209.6	0.00	0.00	0.00
2,100.0	12.13	227.90	2.078.5	-140.5	-171.1	230.6	0.00	0.00	0.00
2,200.0	12.13	227.90	2,176.3	-168.7	-186.7	251.6	0.00	0.00	0.00
2,300.0	12.13	227.90	2,274.1	-182.8	-202.3	272.6	0.00	0.00	0.00
2,400.0	12.13	227.90	2,371.8	-196.9	-217.9	293.6	0.00	0.00	0.00
2,500.0 2,600.0	12.13 12.13	227.90 227.90	2,469.6 2,567.4	-211.0 -225.0	-233.5 -249.1	314.7 335.7	0.00 0.00	0.00 0.00	0.00 0.00
2,700.0	12.13	227.90	2,665.1	-239.1	-249.1	356.7	0.00	0.00	0.00
2,800.0	12.13	227.90	2,762.9	-253.2	-280.3	377.7	0.00	0.00	0.00
2,900.0	12.13	227.90	2,860.7	-267.3	-295.9	398.7	0.00	0.00	0.00
3,000.0	12.13	227.90	2,958.4	-281.4	-311.4	419.8	0.00	0.00	0.00
3,100.0 3,200.0	12.13 12.13	227.90 227.90	3,056.2 3,154.0	-295.5 -309.6	-327.0 -342.6	440.8 461.8	0.00 0.00	0.00 0.00	0.00 0.00
3,300.0	12.13	227.90	3,251.7	-323.7	-358.2	482.8	0.00	0.00	0.00
3,400.0	12.13	227.90	3,349.5	-337.8	-373.8	503.8	0.00	0.00	0.00
3,500.0	12.13	227.90	3,447.3	-351.9	-389.4	524.8	0.00	0.00	0.00
3,600.0 3,700.0	12.13 12.13	227.90 227.90	3,545.0 3,642.8	-366.0 -380.1	-405.0 -420.6	545.9 566.9	0.00 0.00	0.00 0.00	0.00 0.00
						587.9			
3,800.0 3,900.0	12.13 12.13	227.90 227.90	3,740.6 3,838.3	-394.1 -408.2	-436.2 -451.8	608.9	0.00	0.00	0.00 0.00
4,000.0	12.13	227.90	3,936.1	-422.3	-467.4	629.9	0.00	0.00	0.00
4,100.0	12.13	227.90	4,033.9	-436.4	-483.0	651.0	0.00	0.00	0.00
4,200.0 4,300.0	12.13 12.13	227.90 227.90	4,131.6 4,229.4	-450.5 -464.6	-498.6 -514.2	672.0 693.0	0.00 0.00	0.00 0.00	0.00 0.00
4,300.0	12.13	227.90 227.90	4,229.4 4,327.2	-464.6 -478.7	-514.2 -529.8	714.0	0.00	0.00	0.00
4,500.0	12.13	227.90	4,424.9	-492.8	-545.4	735.0	0.00	0.00	0.00
4,600.0	12.13	227.90	4,522.7	-506.9	-561.0	756.0	0.00	0.00	0.00
4,700.0	12.13	227.90	4,620.5	-521.0	-576.6	777.1 709.1	0.00	0.00	0.00
4,800.0 4,900.0	12.13 12.13	227.90 227.90	4,718.2 4,816.0	-535.1 -549.1	-592.2 -607.8	798.1 819.1	0.00 0.00	0.00 0.00	0.00 0.00
5,000.0	12.13	227.90	4,913.7	-563.2	-623.3	840.1	0.00	0.00	0.00
5,100.0	12.13	227.90	5,011.5	-577.3	-638.9	861.1	0.00	0.00	0.00
5,200.0	12.13	227.90	5,109.3	-591.4	-654.5	882.2	0.00	0.00	0.00
5,300.0	12.13	227.90	5,207.0	-605.5	-670.1	903.2	0.00	0.00	0.00



Payzone Directional

Planning Report



Database: Company: Project: Site: EDM 2003.21 Single User Db NEWFIELD EXPLORATION USGS Myton SW (UT) SECTION 29 T8S, R17E

 Well:
 M-29-8-17

 Wellbore:
 Wellbore #1

 Design:
 Design #1

Local Co-ordinate Reference:

TVD Reference:
MD Reference:
North Reference:

Survey Calculation Method:

Well M-29-8-17

M-29-8-17 @ 5293.0ft (Original Well Elev) M-29-8-17 @ 5293.0ft (Original Well Elev)

Grid

Minimum Curvature

Planned Survey									
Measured Depth (ft)	Inclination (°)	Azimuth (°)	Vertical Depth (ft)	+N/-S (ft)	+E/-W (ft)	Vertical Section (ft)	Dogleg Rate (°/100ft)	Build Rate (°/100ft)	Turn Rate (°/100ft)
5,374.6	12.13	227.90	5,280.0	-616.0	-681.8	918.9	0.00	0.00	0.00
5,400.0	12.13	227.90	5,304.8	-619.6	-685.7	924.2	0.00	0.00	0.00
5,500.0	12.13	227.90	5,402.6	-633.7	-701.3	945.2	0.00	0.00	0.00
5,600.0	12.13	227.90	5,500.3	-647.8	-716.9	966.2	0.00	0.00	0.00
5,700.0	12.13	227.90	5,598.1	-661.9	-732.5	987.2	0.00	0.00	0.00
5,800.0	12.13	227.90	5,695.9	-676.0	-748.1	1,008.3	0.00	0.00	0.00
5,900.0	12.13	227.90	5,793.6	-690.1	-763.7	1,029.3	0.00	0.00	0.00
6,000.0	12.13	227.90	5,891.4	-704.2	-779.3	1,050.3	0.00	0.00	0.00
6,100.0	12.13	227.90	5,989.2	-718.2	-794.9	1,071.3	0.00	0.00	0.00
6,200.0	12.13	227.90	6,086.9	-732.3	-810.5	1,092.3	0.00	0.00	0.00
6,300.0	12.13	227.90	6,184.7	-746.4	-826.1	1,113.4	0.00	0.00	0.00
6,400.0	12.13	227.90	6,282.5	-760.5	-841.7	1,134.4	0.00	0.00	0.00
6,500.0	12.13	227.90	6,380.2	-774.6	-857.3	1,155.4	0.00	0.00	0.00
6,600.0	12.13	227.90	6,478.0	-788.7	-872.9	1,176.4	0.00	0.00	0.00
6,673.6	12.13	227.90	6,550.0	-799.1	-884.4	1,191.9	0.00	0.00	0.00

RECEIVED: June 24, 2014

API Well Number: 43013530070000 Project: USGS Myton SW (UT)




Site: SECTION 29 T8S, R17E

Well: M-29-8-17 Wellbore: Wellbore #1 Design: Design #1



Azimuths to Grid North True North: -0.94° Magnetic North: 10.09°

Magnetic Field Strength: 52090.5snT Dip Angle: 65.79° Date: 8/5/2013 Model: IGRF2010

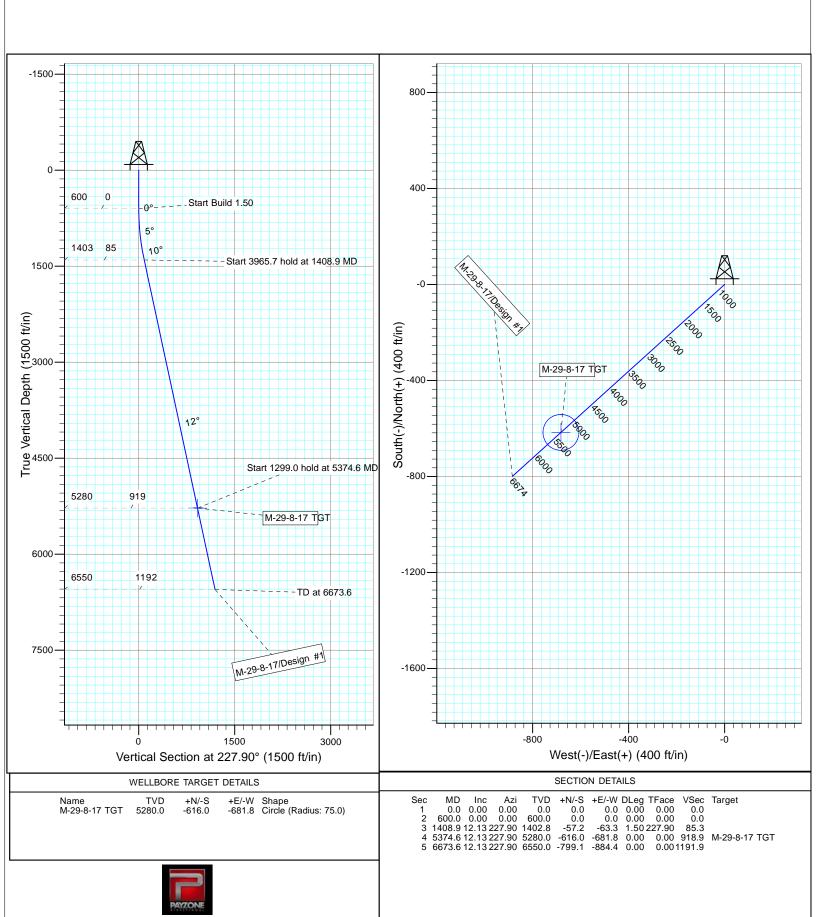

NEWFIELD PRODUCTION COMPANY GMBU M-29-8-17 AT SURFACE: SW/NE SECTION 29, T8S R17E DUCHESNE COUNTY, UTAH

ONSHORE ORDER NO. 1

MULTI-POINT SURFACE USE & OPERATIONS PLAN

1. EXISTING ROADS

See attached Topographic Map "A"

To reach Newfield Production Company well location site GMBU M-29-8-17 located in the SW 1/4 NE 1/4 Section 29, T8S, R17E, Duchesne County, Utah:

Proceed southwesterly out of Myton, Utah along Highway 40 - 1.4 miles \pm to the junction of this highway and UT State Hwy 53; proceed in a southeasterly direction -7.7 miles \pm to it's junction with an existing road to the heast; proceed in a easterly direction -1.3 miles \pm to it's junction with the beginning of the access road to the existing 10-29-8-17 well location.

The aforementioned dirt oil field service roads and other roads in the vicinity are constructed out of existing native materials that are prevalent to the existing area they are located in and range from clays to a sandy-clay shale material.

The roads for access during the drilling, completion and production phase will be maintained at the standards required by the State of Utah, or other controlling agencies. This maintenance will consist of some minor grader work for smoothing road surfaces and for snow removal. Any necessary fill material for repair will be purchase and hauled from private sources.

2. PLANNED ACCESS ROAD

There is no proposed access road for this location. The proposed well will be drilled directionaly off of the existing 10-29-8-17 well pad. See attached **Topographic Map "B"**.

There will be **no** culverts required along this access road. There will be barrow ditches and turnouts as needed along this road.

There are no fences encountered along this proposed road. There will be no new gates or cattle guards required.

All construction material for this access road will be borrowed material accumulated during construction of the access road.

3. LOCATION OF EXISTING WELLS

Refer to Exhibit "B".

4. <u>LOCATION OF EXISTING AND/OR PROPOSED FACILITIES</u>

There are no existing facilities that will be used by this well.

It is anticipated that this well will be a producing oil well.

Upon construction of a tank battery, the well pad will be surrounded by a dike of sufficient capacity to contain at minimum 110% of the largest tank volume within the facility battery.

Tank batteries will be built to State specifications.

All permanent (on site for six (6) months or longer) structures, constructed or installed (including pumping units), will be painted a flat, non-reflective, earth tone color to match one of the standard environmental colors, as determined by the Rocky Mountain Five State Interagency Committee. All facilities will be painted within six months of installation.

5. <u>LOCATION AND TYPE OF WATER SUPPLY</u>

Newfield Production will transport water by truck from nearest water source as determined by a Newfield representative for the purpose of drilling the above mentioned well. The available water sources are as follows:

Johnson Water District Water Right: 43-7478

Maurice Harvey Pond Water Right: 47-1358

Neil Moon Pond

Water Right: 43-11787

Newfield Collector Well

Water Right: 47-1817 (A30414DVA, contracted with the Duchesne County Conservancy

District).

There will be no water well drilled at this site.

6. <u>SOURCE OF CONSTRUCTION MATERIALS</u>

All construction material for this location shall be borrowed material accumulated during construction of the location site and access road.

A mineral material application is not required for this location.

7. <u>METHODS FOR HANDLING WASTE DISPOSAL</u>

A small reserve pit (90' x 40' x 8' deep, or less) will be constructed from native soil and clay materials. The reserve pit will receive the processed drill cutting (wet sand, shale & rock) removed from the wellbore. Any drilling fluids, which do accumulate in the pit as a result of shale-shaker carryover, cleaning of the sand trap, etc., will be promptly reclaimed. All drilling fluids will be fresh water based, typically containing Total Dissolved Solids of less than 3000 PPM. No potassium chloride, chromates, trash, debris, nor any other substance deemed hazardous will be placed in this pit. Therefore, it is proposed that no synthetic liner be required in the reserve pit. However, if upon constructing the pit there is insufficient fine clay and silt present, a liner will be used for the purpose of reducing water loss through percolation.

Newfield requests approval that a flare pit not be constructed or utilized on this location.

A portable toilet will be provided for human waste.

A trash basket will be provided for garbage (trash) and hauled away to an approved disposal site at the completion of the drilling activities.

8. ANCILLARY FACILITIES

There are no ancillary facilities planned for at the present time and none foreseen in the near future.

9. WELL SITE LAYOUT

See attached Location Layout Sheet.

Fencing Requirements

- All pits will be fenced or have panels installed consistent with the following minimum standards:
 - 1. The wire shall be no more than two (2) inches above the ground. If barbed wire is utilized it will be installed three (3) inches above the net wire. Total height of the fence shall be at least forty-two (42) inches.
 - Corner posts shall be centered and/or braced in such a manner to keep tight and upright at all times
 - 3. Standard steel, wood or pipe posts shall be used between the corner braces. Maximum distance between any two posts shall be no greater than sixteen (16) feet.

The reserve pit fencing will be on three (3) sides during drilling operations and on the fourth side when the rig moves off location. Pits will be fenced and maintained until cleanup.

Existing fences to be crossed by the access road will be braced and tied off before cutting so as to prevent slacking in the wire. The opening shall be closed temporarily as necessary during construction to prevent the escape of livestock, and upon completion of construction the fence shall be repaired to BLM specifications.

10. PLANS FOR RESTORATION OF SURFACE:

a) Producing Location

Immediately upon well completion, the location and surrounding area will be cleared of all unused tubing, equipment, debris, material, trash and junk not required for production.

The reserve pit and that portion of the location not needed for production facilities/operations will be recontoured to the approximated natural contours. Weather permitting, the reserve pit will be reclaimed within one hundred twenty (120) days from the date of well completion. Before any dirt work takes place, the reserve pit must have all fluids and hydrocarbons removed.

b) Dry Hole Abandoned Location

At such time as the well is plugged and abandoned, the operator shall submit a subsequent report of abandonment and the State of Utah will attach the appropriate surface rehabilitation conditions of approval.

11. <u>SURFACE OWNERSHIP</u> – Bureau of Land Management.

12. OTHER ADDITIONAL INFORMATION

The Archaeological Resource Survey and Paleontological Resource Survey for this area are attached. MOAC Report # 13-275 12/6/13, prepared by Montgomery Archaeological Consultants. . Paleontological Resource Survey prepared by, SWCA Environmental Consultants, Report No. UT14-14273-19, April 2014

Newfield Production Company requests 3,654' of buried water line be granted.

It is proposed that the disturbed area will be 30' wide to allow for construction of a proposed buried 10" steel water injection line, a buried 3" poly water return line, and a and a 14" surface flow line. It is proposed that the buried water lines will tie in to the existing pipeline infrastructure. **Refer to Topographic Map "C."** The proposed water pipelines will be buried in a 4-5' deep trench constructed with a trencher or backhoe for the length of the proposal. The equipment will run on the surface and not be flat bladed to minimize surface impacts to precious topsoil in these High Desert environments. The construction phase of the proposed water lines will last approximately (5) days.

In the event that the proposed well is converted to a water injection well, a Sundry Notice 3160-5 form will be applied for through the Bureau of Land Management field office.

For a ROW plan of development, please refer to the Greater Monument Butte Green River Development SOP and as well as the Castle Peak and Eight Mile Flat Reclamation and Weed Management Plan.

Water Disposal

After first production, if the production water meets quality guidelines, it will be transported to the Ashley, Monument Butte, Jonah, South Wells Draw and Beluga water injection facilities by company or contract trucks. Subsequently, the produced water is injected into approved Class II wells to enhance Newfield's secondary recovery project. Water not meeting quality criteria, will be disposed at Newfield's Pariette #4 disposal well (Sec. 7, T9S R19E), Federally approved surface disposal facilities or at a State of Utah approved surface disposal facilities.

Additional Surface Stipulations

All lease and/or unit operations will be conducted in such a manner that full compliance is made with all applicable laws and regulations, Onshore Oil and Gas Orders, the approved plan of operations and any applicable Notice to Lessees. A copy of these conditions will be furnished to the field representative to ensure compliance.

Hazardous Material Declaration

Newfield Production Company guarantees that during the drilling and completion of the GMBU M-29-8-17, Newfield will not use, produce, store, transport or dispose 10,000# annually of any of the hazardous chemicals contained in the Environmental Protection Agency's consolidated list of chemicals subject to reporting under Title III Superfund Amendments and Reauthorization Act (SARA) of 1986. Newfield also guarantees that during the drilling and completion of the GMBU M-29-8-17, Newfield will use, produce, store, transport or dispose less than the threshold planning quantity (T.P.Q.) of any extremely hazardous substances as defined in 40 CFR 355.

A complete copy of the approved APD, if applicable, shall be on location during the construction of the location and drilling activities.

Newfield Production Company or a contractor employed by Newfield Production shall contact the State office at (801) 722-3417, 48 hours prior to construction activities.

13. <u>LESSEE'S OR OPERATOR'S REPRENSENTATIVE AND CERTIFICATION:</u>

Representative

Name: Corie Miller

Address: Newfield Production Company

Route 3, Box 3630 Myton, UT 84052

Telephone: (435) 646-3721

RECEIVED: June 24, 2014


Certification

Please be advised that NEWFIELD PRODUCTION COMPANY is considered to be the operator of well #M-29-8-17, Section 29, Township 8S, Range 17E: Lease UTU-76956 Duchesne County, Utah: and is responsible under the terms and conditions of the lease for the operations conducted upon the leased lands. Bond coverage is provided by, Federal Bond #WYB000493.


I hereby certify that the proposed drill site and access route have been inspected, and I am familiar with the conditions which currently exist; that the statements made in this plan are true and correct to the best of my knowledge; and that the work associated with the operations proposed here will be performed by Newfield Production Company and its contractors and subcontractors in conformity with this plan and the terms and conditions under which it is approved. This statement is subject to the provisions of the 18 U.S.C. 1001 for the filing of a false statement.


(5/24/14	
Date		Heather Calder
		Regulatory Technician
		Newfield Production Company

Typical 2M BOP stack configuration

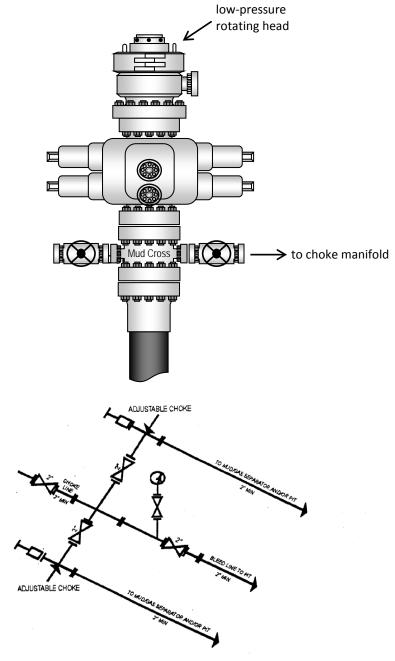

2M CHOKE MANIFOLD EQUIPMENT - CONFIGURATION OF CHOKES MAY VARY

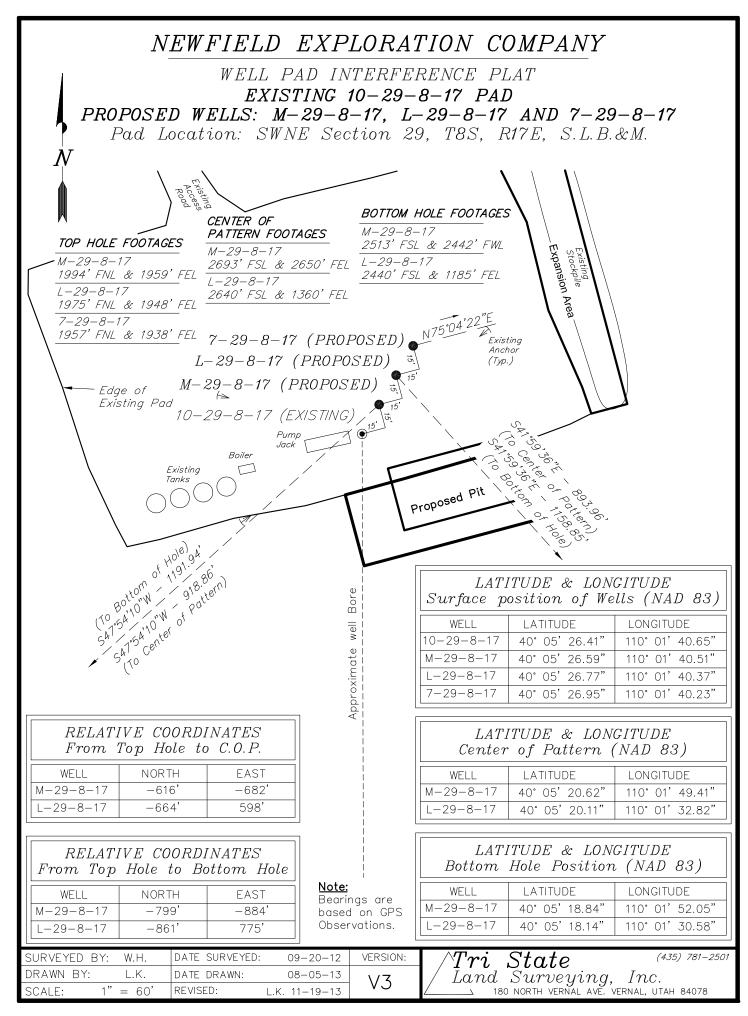

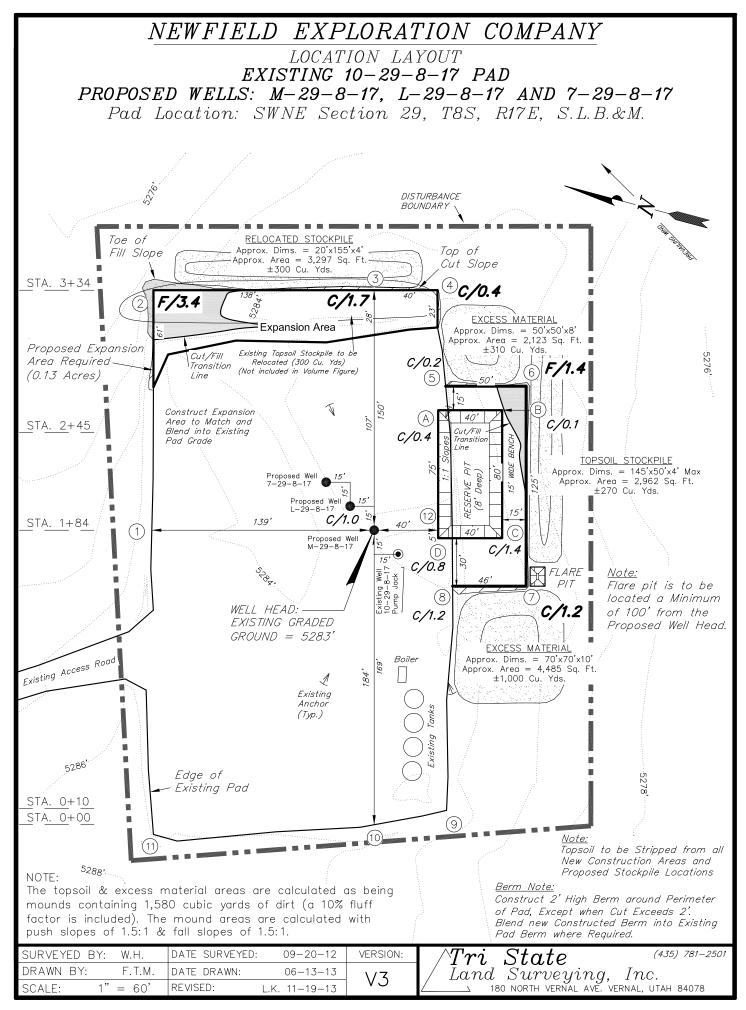



NEWFIELD EXPLORATION COMPANY


CROSS SECTIONS EXISTING 10-29-8-17 PAD

PROPOSED WELLS: M-29-8-17, L-29-8-17 AND 7-29-8-17

Pad Location: SWNE Section 29, T8S, R17E, S.L.B.&M.

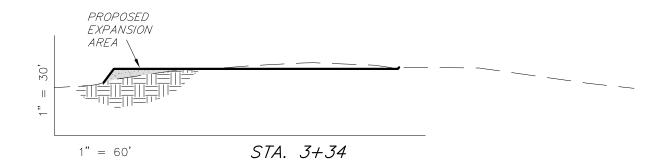

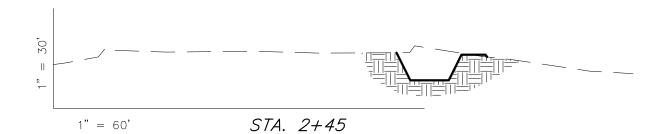

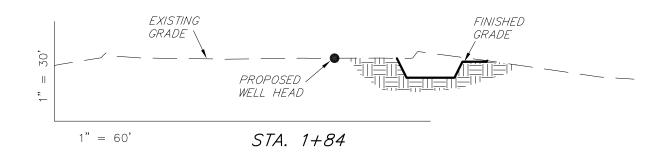



NOTE: UNLESS OTHERWISE NOTED ALL CUT/FILL SLOPES ARE AT 1.5:1 (No Shrink or swell adjustments have been used) (Expressed in Cubic Yards) CUT 6" TOPSOIL ITEM FILL **EXCESS** Topsoil is not included in Pad Cut PAD 500 500 PIT 690 0 690 TOTALS 1,190 250 1,190

SURVEYED BY:	W.H.	DATE SURVEYED:	09-20-12	VERSION:
DRAWN BY:	F.T.M.	DATE DRAWN:	06-13-13	\/3
SCALE: 1"	= 60'	REVISED:	L.K. 11-19-13	VJ

 $egin{array}{ccccc} Tri & State & ^{ ext{(435)}} & ext{781-2501} \ & Land & Surveying, & Inc. \ & _ & ext{180 NORTH VERNAL AVE. VERNAL, UTAH 84078} \end{array}$

DRAWN BY:

SCALE:

F.T.M.

1" = 60'

DATE DRAWN:

REVISED:

06-13-13

L.K. 11-19-13

V3

API Well Number: 43013530070000 NEWFIELD EXPLORATION COMPANY TYPICAL RIG LAYOUT EXISTING 10-29-8-17 PAD PROPOSED WELLS: M-29-8-17, L-29-8-17 AND 7-29-8-17 Pad Location: SWNE Section 29, T8S, R17E, S.L.B.&M. STORAGE TANK YELLOW 50' BOILER 15, PUMP BENCH RESERVE PIT (8' Deep) JOIM 15, PARTS HOUSE ☐ TOILET 139' TRAILERS Existing Well 10-29-8-17 PIPE RACKS 46' PIPE RACKS Existing Access Road 184' Tri~State (435) 781-. Land~Surveying,~Inc. ightharpoonup 180~NORTH~VERNAL~AVE.~VERNAL,~UTAH~84078SURVEYED BY: W.H. DATE SURVEYED: 09-20-12 VERSION:

RECEIVED: June 24, 2014


NEWFIELD EXPLORATION COMPANY

RECLAMATION LAYOUT

EXISTING 10-29-8-17 PAD

PROPOSED WELLS: M-29-8-17, L-29-8-17 AND 7-29-8-17

Pad Location: SWNE Section 29, T8S, R17E, S.L.B.&M.

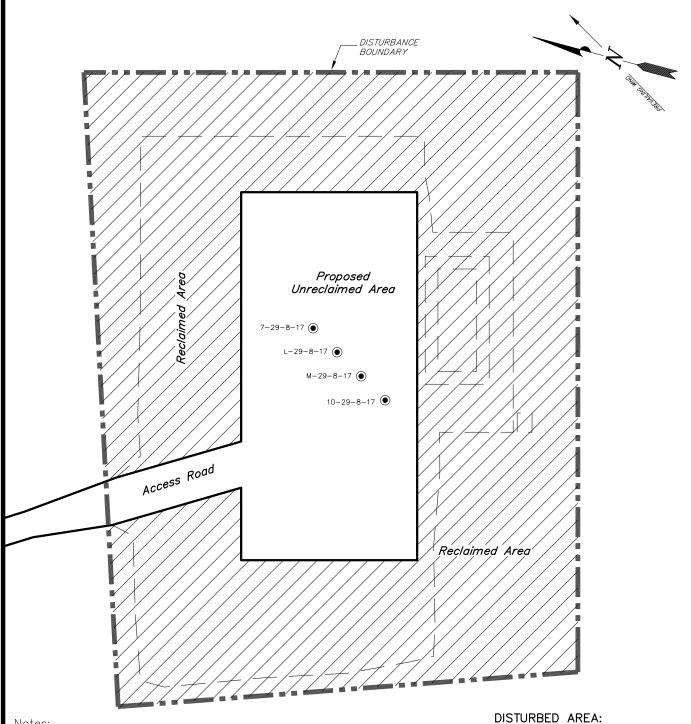

Notes

1. Reclaimed Area to Include Seeding of Approved Vegetation and Sufficient Storm Water Management System.

2. Actual Equipment Layout and Reclaimed Pad Surface Area May Change due to Production Requirements or Site Conditions. DISTURDED AREA - 1264

TOTAL DISTURBED AREA = ± 2.64 ACRES TOTAL RECLAIMED AREA = ± 2.00 ACRES UNRECLAIMED AREA = ± 0.64 ACRES

SURVEYED E	Y: W.H.	DATE SURVEYED:	: 09-20-12	VERSION:
DRAWN BY:	F.T.M.	DATE DRAWN:	06-13-13	1/3
SCALE:	1" = 60'	REVISED:	L.K. 11-19-13	٧٥

/Tri~State (435) 781-2501 Land Surveying, Inc. $_$ 180 north vernal ave. Vernal, Utah 84078

NEWFIELD EXPLORATION COMPANY

PROPOSED SITE FACILITY DIAGRAM

10-29-8-17 PAD

10-29-8-17 UTU-76956


M-29-8-17 *UTU*-76956

L-29-8-17 *UTU*-76956

7-29-8-17 UTU-76956

Pad Location: SWNE Section 29, T8S, R17E, S.L.B.&M.

Duchesne County, Utah

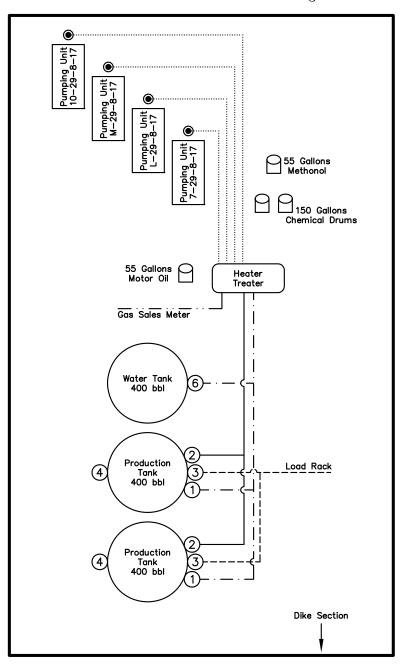


<u>Legend</u>

NOT TO SCALE

SURVEYED BY:	W.H.	DATE SURVEYED:	09-20-12	VERSION:	$\wedge Tri$ S
DRAWN BY:	F.T.M.	DATE DRAWN:	06-13-13	1/7	$/$ Land $\tilde{\lambda}$
SCALE:	NONE	REVISED:	L.K. 11-19-13	٧٥	

/Tri State (435) 781-2501 Land Surveying, Inc.

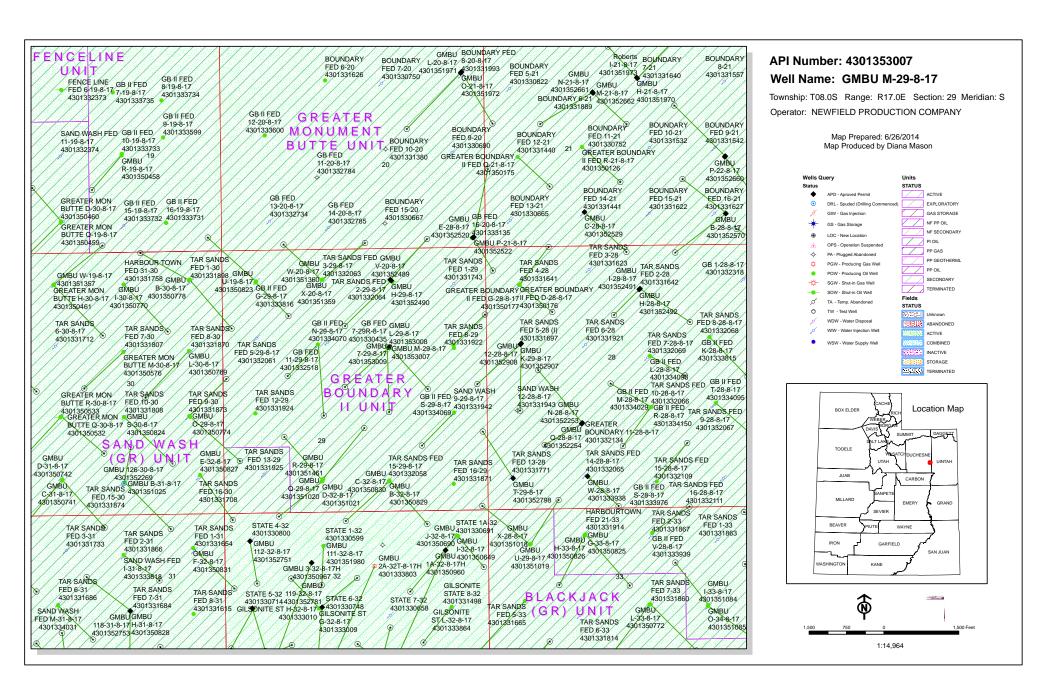

WORKSHEET APPLICATION FOR PERMIT TO DRILL

APD RECEIVED: 6/24/2014	API NO. ASSIGNED:	43013530070000

WELL NAME: GMBU M-29-8-17

OPERATOR: NEWFIELD PRODUCTION COMPANY (N2695) PHONE NUMBER: 435 646-4936

CONTACT: Heather Calder

PROPOSED LOCATION: SWNE 29 080S 170E Permit Tech Review:

SURFACE: 1994 FNL 1959 FEL Engineering Review:

BOTTOM: 2513 FSL 2442 FWL Geology Review:

COUNTY: DUCHESNE

LATITUDE: 40.09073 LONGITUDE: -110.02787

UTM SURF EASTINGS: 582871.00 **NORTHINGS:** 4438280.00

FIELD NAME: MONUMENT BUTTE

LEASE TYPE: 1 - Federal

LEASE NUMBER: UTU-76956 PROPOSED PRODUCING FORMATION(S): GREEN RIVER

SURFACE OWNER: 1 - Federal COALBED METHANE: NO

RECEIVED AND/OR REVIEWED: LOCATION AND SITING: ✓ PLAT R649-2-3. Unit: GMBU (GRRV) Bond: FEDERAL - WYB000493 **Potash** R649-3-2. General Oil Shale 190-5 Oil Shale 190-3 R649-3-3. Exception **Drilling Unit** Oil Shale 190-13 Board Cause No: Cause 213-11 Water Permit: 437478 Effective Date: 11/30/2009 **RDCC Review:** Siting: Suspends General Siting Fee Surface Agreement

Intent to Commingle R649-3-11. Directional Drill

Commingling Approved

-----g....g...pp.-----

Comments: Presite Completed

Stipulations: 4 - Federal Approval - dmason

15 - Directional - dmason

27 - Other - bhill

RECEIVED: July 01, 2014



State of Utah

DEPARTMENT OF NATURAL RESOURCES

MICHAEL R. STYLER
Executive Director

Division of Oil, Gas and Mining

JOHN R. BAZA
Division Director

Permit To Drill

Well Name: GMBU M-29-8-17 **API Well Number:** 43013530070000

Lease Number: UTU-76956 Surface Owner: FEDERAL Approval Date: 7/1/2014

Issued to:

NEWFIELD PRODUCTION COMPANY, Rt 3 Box 3630, Myton, UT 84052

Authority:

Pursuant to Utah Code Ann. 40-6-1 et seq., and Utah Administrative Code R649-3-1 et seq., the Utah Division of Oil, Gas and Mining issues conditions of approval, and permit to drill the listed well. This permit is issued in accordance with the requirements of Cause 213-11. The expected producing formation or pool is the GREEN RIVER Formation(s), completion into any other zones will require filing a Sundry Notice (Form 9). Completion and commingling of more than one pool will require approval in accordance with R649-3-22.

Duration:

This approval shall expire one year from the above date unless substantial and continuous operation is underway, or a request for extension is made prior to the expiration date

General:

Compliance with the requirements of Utah Admin. R. 649-1 et seq., the Oil and Gas Conservation General Rules, and the applicable terms and provisions of the approved Application for permit to drill.

Conditions of Approval:

State approval of this well does not supercede the required federal approval, which must be obtained prior to drilling.

In accordance with Utah Admin. R.649-3-11, Directional Drilling, the operator shall submit a complete angular deviation and directional survey report to the Division within 30 days following completion of the well.

Production casing cement shall be brought up to or above the top of the unitized interval for the Greater Monument Butte Unit (Cause No. 213-11).

Notification Requirements:

The operator is required to notify the Division of Oil, Gas and Mining of the following actions during drilling of this well:

• Within 24 hours following the spudding of the well - contact Carol Daniels at 801-538-5284

(please leave a voicemail message if not available) OR

submit an electronic sundry notice (pre-registration required) via the Utah Oil & Gas website

at http://oilgas.ogm.utah.gov

Reporting Requirements:

All reports, forms and submittals as required by the Utah Oil and Gas Conservation General Rules will be promptly filed with the Division of Oil, Gas and Mining, including but not limited to:

- Entity Action Form (Form 6) due within 5 days of spudding the well
- Monthly Status Report (Form 9) due by 5th day of the following calendar month
 - Requests to Change Plans (Form 9) due prior to implementation
 - Written Notice of Emergency Changes (Form 9) due within 5 days
- Notice of Operations Suspension or Resumption (Form 9) due prior to implementation
 - Report of Water Encountered (Form 7) due within 30 days after completion
- Well Completion Report (Form 8) due within 30 days after completion or plugging

Approved By:

For John Rogers Associate Director, Oil & Gas Sundry Number: 63518 API Well Number: 43013530070000

STATE OF UTAH DEPARTMENT OF NATURAL RESOURCES DIVISION OF OIL, GAS, AND MINING SUNDRY NOTICES AND REPORTS ON WELLS Do not use this form for proposals to drill new wells, significantly deepen existing wells below current bottom-hole depth, reenter plugged wells, or to drill horizontal laterals. Use APPLICATION CAMBLE (CRINA)	RM 9	
DIVISION OF OIL, GAS, AND MINING SUNDRY NOTICES AND REPORTS ON WELLS Do not use this form for proposals to drill new wells, significantly deepen existing wells below current bottom-hole depth, reenter plugged wells, or to drill horizontal laterals. Use APPLICATION 5.LEASE DESIGNATION AND SERIAL NUM UTU-76956 6. IF INDIAN, ALLOTTEE OR TRIBE NAMI 7.UNIT or CA AGREEMENT NAME:		
Do not use this form for proposals to drill new wells, significantly deepen existing wells below current bottom-hole depth, reenter plugged wells, or to drill horizontal laterals. Use APPLICATION 7.UNIT or CA AGREEMENT NAME:	5.LEASE DESIGNATION AND SERIAL NUMBER: UTU-76956	
current bottom-hole depth, reenter plugged wells, or to drill horizontal laterals. Use APPLICATION CANDID CORREMENT NAME:	Ē:	
FOR PERMIT TO DRILL form for such proposals.		
1. TYPE OF WELL Oil Well 8. WELL NAME and NUMBER: GMBU M-29-8-17		
2. NAME OF OPERATOR: NEWFIELD PRODUCTION COMPANY 9. API NUMBER: 43013530070000		
3. ADDRESS OF OPERATOR: PHONE NUMBER: 9. FIELD and POOL or WILDCAT: Rt 3 Box 3630 , Myton, UT, 84052 435 646-4825 Ext MONUMENT BUTTE		
4. LOCATION OF WELL FOOTAGES AT SURFACE: 1994 FNL 1959 FEL COUNTY: DUCHESNE	1	
QTR/QTR, SECTION, TOWNSHIP, RANGE, MERIDIAN: Qtr/Qtr: SWNE Section: 29 Township: 08.0S Range: 17.0E Meridian: S STATE: UTAH		
CHECK APPROPRIATE BOXES TO INDICATE NATURE OF NOTICE, REPORT, OR OTHER DATA		
TYPE OF SUBMISSION TYPE OF ACTION		
☐ ACIDIZE ☐ ALTER CASING ☐ CASING REPAIR		
✓ NOTICE OF INTENT Approximate date work will start: □ CHANGE TO PREVIOUS PLANS □ CHANGE TUBING □ CHANGE WELL NAME 7/1/2015 □ CHANGE WELL NAME		
CHANGE WELL STATUS COMMINGLE PRODUCING FORMATIONS CONVERT WELL TYPE		
SUBSEQUENT REPORT Date of Work Completion: DEEPEN FRACTURE TREAT NEW CONSTRUCTION		
OPERATOR CHANGE PLUG AND ABANDON PLUG BACK		
PRODUCTION START OR RESUME RECLAMATION OF WELL SITE RECOMPLETE DIFFERENT FORMATION		
Date of Spud: REPERFORATE CURRENT FORMATION SIDETRACK TO REPAIR WELL TEMPORARY ABANDON		
TUBING REPAIR VENT OR FLARE WATER DISPOSAL		
☐ DRILLING REPORT ☐ WATER SHUTOFF ☐ SI TA STATUS EXTENSION ✓ APD EXTENSION Report Date:		
☐ WILDCAT WELL DETERMINATION ☐ OTHER OTHER:		
12. DESCRIBE PROPOSED OR COMPLETED OPERATIONS. Clearly show all pertinent details including dates, depths, volumes, etc. Newfield proposes to extend the Application for Permit to Drill this well. Approved by the Utume 08;52015 f Oil, Gas and Mining	_	
By: Date:	_	
L nowall		

Sundry Number: 63518 API Well Number: 43013530070000



The Utah Division of Oil, Gas, and Mining

- State of Utah
- Department of Natural Resources

Electronic Permitting System - Sundry Notices

Request for Permit Extension Validation Well Number 43013530070000

API: 43013530070000 **Well Name:** GMBU M-29-8-17

Location: 1994 FNL 1959 FEL QTR SWNE SEC 29 TWNP 080S RNG 170E MER S

Company Permit Issued to: NEWFIELD PRODUCTION COMPANY

Date Original Permit Issued: 7/1/2014

The undersigned as owner with legal rights to drill on the property as permitted above, hereby verifies that the information as submitted in the previously approved application to drill, remains valid and does not require revision. Following is a checklist of some items related to the application, which should be verified.

• If located on private land, has the ownership changed, if so, has the surface agreement been updated? Yes No
Have any wells been drilled in the vicinity of the proposed well which would affect the spacing or siting requirements for this location? Yes No
• Has there been any unit or other agreements put in place that could affect the permitting or operation of this proposed well? Yes No
• Have there been any changes to the access route including ownership, or rightof- way, which could affect the proposed location? Yes No
• Has the approved source of water for drilling changed? Yes No
 Have there been any physical changes to the surface location or access route which will require a change in plans from what was discussed at the onsite evaluation? Yes No
• Is bonding still in place, which covers this proposed well? Yes No
nature: Mandie Crozier Date: 5/27/2015

Form 3160-3 (August 2007)

RECEIVED

UNITED STATES DEPARTMENT OF THE INTERIOR JUN 2 6 2014 **BUREAU OF LAND MANAGEMENT**

FORM APPROVED OMB No. 1004-0136 Expires July 31, 2010

5. Lease Serial No. UTU76956

6. If Indian, Allottee or Tribe Name

APPLICATION FOR PERMIT	6. If Indian, Allottee or Trib	e Name	
1a. Type of Work:		7. If Unit or CA Agreement, UTU87538X	Name and No.
1b. Type of Well:	ner 🔀 Single Zone 🔲 Multiple Zone	8. Lease Name and Well No GMBU M-29-8-17	
	HEATHER A CALDER	9. API Well No.	53007
3a. Address ROUTE 3 BOX 3630 MYTON, UT 84052	3b. Phone No. (include area code) Ph: 435-646-4936 Fx: 435-646-3031	10. Field and Pool, or Explo MONUMENT BUTTE	ratory
4. Location of Well (Report location clearly and in accorda	nce with any State requirements.*)	11. Sec., T., R., M., or Blk. a	and Survey or Area
At surface SWNE 1994FNL 1959FEL		Sec 29 T8S R17E M	er SLB
At proposed prod. zone NESW 2513FSL 2442FWL		į	
14. Distance in miles and direction from nearest town or post of 10.4	office*	12. County or Parish DUCHESNE	13. State UT
15. Distance from proposed location to nearest property or lease line, ft. (Also to nearest drig, unit line, if any)	16. No. of Acres in Lease	17. Spacing Unit dedicated t	o this well
2442	600.00	20.00	
18. Distance from proposed location to nearest well, drilling,	19. Proposed Depth	20. BLM/BIA Bond No. on file	
completed, applied for, on this lease, ft.	6674 MD 6550 TVD	WYB000493	
21. Elevations (Show whether DF, KB, RT, GL, etc. 5283 GL	22. Approximate date work will start 09/01/2014	23. Estimated duration 7 DAYS	ENED SOLD
	24. Attachments	KE	. 2015
The following, completed in accordance with the requirements o	f Onshore Oil and Gas Order No. 1, shall be attached to t	his form: NO	MILAN
Well plat certified by a registered surveyor.	4. Bond to cover the operation	ns unless covered by an existing	s bond on his (see
 A Drilling Plan. A Surface Use Plan (if the location is on National Forest Systems SUPO shall be filed with the appropriate Forest Service Off 		formation and/or plans 2 may b	e required by the
25. Signature (Electronic Submission)	Name (Printed/Typed) HEATHER A CALDER Ph: 435-646-493		Date 06/24/2014
Title REGULATORY TECHNICIAN			
Approved by (Signature)	Name (Printed/Typed) Jerry Kencz	ka	Date OCT 2 7 2015
Title Assistant Field Manager Lands & Mineral Resources	Office VERNAL FIELD OFFICE		
Application approval does not warrant or certify the applicant ho operations thereon. Conditions of approval, if any, are attached.	lds legal or equitable title to those rights in the subject le	ase which would entitle the appl	icant to conduct

Additional Operator Remarks (see next page)

Electronic Submission #250691 verified by the BLM Well Information System For NEWFIELD EXPLORATION, sent to the Vernal Committed to AFMSS for processing by JEANNE NEWMAN on 07/01/2014 ()

Title 18 U.S.C. Section 1001 and Title 43 U.S.C. Section 1212, make it a crime for any person knowingly and willfully to make to any department or agency of the United States any false, fictitious or fraudulent statements or representations as to any matter within its jurisdiction.

NOTICE OF APPROVAL CONDITIONS OF APPROVAL ATTACHED

** OPERATOR-SUBMITTED ** OPERATOR-SUBMITTED ** OPERATOR-SUBMITTED **



UNITED STATES DEPARTMENT OF THE INTERIOR BUREAU OF LAND MANAGEMENT VERNAL FIELD OFFICE

VERNAL, UT 84078

(435) 781-4400



CONDITIONS OF APPROVAL FOR APPLICATION FOR PERMIT TO DRILL

Company: Well No: API No: **Newfield Exploration Company**

GMBU M-29-8-17

43-013-53007

Location: Lease No:

Agreement:

SWNE, Sec 29, T8S, R17E

UTU 76956

Monument Butte

OFFICE NUMBER:

(435) 781-4400

OFFICE FAX NUMBER:

(435) 781-3420

A COPY OF THESE CONDITIONS SHALL BE FURNISHED TO YOUR FIELD REPRESENTATIVE TO INSURE COMPLIANCE

All lease and/or unit operations are to be conducted in such a manner that full compliance is made with the applicable laws, regulations (43 CFR Part 3160), and this approved Application for Permit to Drill including Surface and Downhole Conditions of Approval. The operator is considered fully responsible for the actions of his subcontractors. A copy of the approved APD must be on location during construction, drilling, and completion operations. This permit is approved for a two (2) year period, or until lease expiration, whichever occurs first. An additional extension, up to two (2) years, may be applied for by sundry notice prior to expiration.

NOTIFICATION REQUIREMENTS

Construction Activity (Notify Ute Tribe Energy & Minerals Dept. and BLM Environmental Scientist)	 The Ute Tribe Energy & Minerals Dept. and BLM Environmental Scientist shall be notified at least 48 hours in advance of any construction activity. The Ute Tribal office is open Monday through Thursday.
Construction Completion (Notify Ute Tribe Energy & Minerals Dept. and BLM Environmental Scientist)	 Upon completion of the pertinent APD/ROW construction, notify the Ute Tribe Energy & Minerals Dept. for a Tribal Technician to verify the Affidavit of Completion. Notify the BLM Environmental Scientist prior to moving on the drilling rig.
Spud Notice (Notify BLM Petroleum Engineer)	- Twenty-Four (24) hours prior to spudding the well.
Casing String & Cementing (Notify BLM Supv. Petroleum Tech.)	 Twenty-Four (24) hours prior to running casing and cementing all casing strings to: <u>blm_ut_vn_opreport@blm.gov</u>
BOP & Related Equipment Tests (Notify BLM Supv. Petroleum Tech.)	- Twenty-Four (24) hours prior to initiating pressure tests.
First Production Notice (Notify BLM Petroleum Engineer)	 Within Five (5) business days after new well begins or production resumes after well has been off production for more than ninety (90) days.

Page 2 of 10 Well: GMBU M-29-8-17 10/22/2015

SURFACE USE PROGRAM CONDITIONS OF APPROVAL (COAs)

- All new and replacement internal combustion gas field engines of less than or equal to 300 design-rated horsepower must not emit more than 2 gms of NO_x per horsepower-hour. This requirement does not apply to gas field engines of less than or equal to 40 design-rated horsepower.
- All and replacement internal combustion gas field engines of greater than 300 design rated horsepower must not emit more than 1.0 gms of NO_x per horsepower-hour.
- If there is an active Gilsonite mining operation within 2 miles of the well location, operator shall notify the Gilsonite operator at least 48 hours prior to any blasting during construction.
- If paleontological materials are uncovered during construction, the operator is to immediately stop work and contact the Authorized Officer (AO). A determination will be made by the AO as to what mitigation may be necessary for the discovered paleontologic material before construction can continue.

Green River District Reclamation Guidelines

The Operator will comply with the requirements of the *Green River District (GRD) Reclamation Guidelines* formalized by Green River District Instructional Memo UTG000-2014-004 on May 21, 2014.

CONDITIONS OF APPROVAL

Wildlife

In accordance with the Record of Decision for the Castle Peak and Eightmile Flat Oil and Gas Expansion Project, Newfield Rocky Mountains Inc., the following COA's are required:

- WFM-1 On level or gently sloping ground (5 percent slope or less) Newfield will elevate surface pipelines (4 inches or greater in diameter) a minimum of 6 inches above the ground to allow passage of small animals beneath the pipe. This ground clearance will be achieved by placing the pipeline on blocks at intervals of 150 to 200 feet.
- WFM-4 Newfield will install noise reduction devices on all pump jacks to reduce intermittent noise to 45 dBA at 660 feet from the source.

COA's derived from mitigating measures in the EA:

If construction and drilling is anticipated during any of the following wildlife seasonal spatial restrictions, a BLM biologist or a qualified consulting firm biologist must conduct applicable surveys using an accepted protocol prior to any ground disturbing activities.

 If it is anticipated that construction or drilling will occur during burrowing owl nesting season (March 1 – August 31), a BLM biologist will be notified to determine if surveys are necessary prior to beginning operations. If surveys are deemed necessary, depending on the results permission to proceed may or may not, be granted by the BLM Authorized Officer.

Page 3 of 10 Well: GMBU M-29-8-17 10/22/2015

• If the surface disturbing activities are planned during the current timing restrictions for the ferruginous hawk (March 1st through August 1st) a survey for nesting ferruginous hawk is required. Based on the results of the survey permission to proceed may or may not be granted.

For protection of T&E Fish if drawing water from the Green River

- For areas of fresh water collection, an infiltration gallery will be constructed in a Service
 approved location. An infiltration gallery is basically a pit or trench dug within the floodplain to a
 depth below the water table. Water is drawn from the pit rather than from the river directly. If
 this is not possible, limit pumping within the river to off-channel locations that do not connect to
 the river during high spring flows.
- If water cannot be drawn using the measures above and the pump head will be located in the river channel where larval fish are known to occur, the following measures apply:
 - Avoid pumping from low-flow or no-flow areas as these habitats tend to concentrate larval fished
 - Avoid pumping to the greatest extent possible, during that period of the year when larval fish may be present (see previous bullet); and
 - Avoid pumping, to the greatest extent possible, during the midnight hours (10:00 p.m. to 2:00 a.m.) as larval drift studies indicate that this is a period of greatest daily activity.
 Dusk is the preferred pumping time, as larval drift abundance is lowest during this time.
 - o Screen all pump intakes with 3/32-inch mesh material.
- Report any fish impinged on the intake screen to the FWS office (801.975.3330) and the:

Utah Division of Wildlife Resources Northeastern Region 318 N Vernal Ave. Vernal, UT 84078 (435) 781-9453

Air Quality

- All internal combustion equipment will be kept in good working order.
- Water or other approved dust suppressants will be used at construction sites and along roads, as determined appropriate by the Authorized Officer. Dust suppressant such as magnesium chloride or fresh water may be used, as needed, during the drilling phase.
- Open burning of garbage or refuse will not occur at well sites or other facilities.
- Drill rigs will be equipped with Tier II or better diesel engines.
- Low bleed pneumatics will be installed on separator dump valves and other controllers.
- During completion, no venting will occur, and flaring will be limited as much as possible. Production equipment and gathering lines will be installed as soon as possible.
- Telemetry will be installed to remotely monitor and control production.

Page 4 of 10 Well: GMBU M-29-8-17 10/22/2015

- When feasible, two or more rigs (including drilling and completion rigs) will not be run simultaneously within 200 meters of each other, then effective public health buffer zones out to 200 meters (m) from the nearest emission source will be implemented. Examples of an effective public health protection buffer zone include the demarcation of a public access exclusion zone by signage at intervals of every 250 feet that is visible from a distance of 125 feet during daylight hours, and a physical buffer such as active surveillance to ensure the property is not accessible by the public during drilling operations. Alternatively, the proponent may demonstrate compliance with the 1-hour NO₂ National Ambient Air Quality Standards (NAAQS) with appropriate and accepted near-field modeling. As part of this demonstration, the proponent may propose alternative mitigation that could include but is not limited to natural gas—fired drill rigs, installation of NO_X controls, time/use restrictions, and/or drill rig spacing.
- All new and replacement internal combustion gas field engines of less than or equal to 300 design-rated horse power must not emit more than 2 grams of NO_X per horsepower-hour. This requirement does not apply to gas field engines of less than or equal to 40 design-rated horsepower-hour.
- All new and replacement internal combustion gas field engines of greater than 300 design rated horsepower must not emit more than 1.0 grams of NO_x per horsepower-hour.
- Green completions will be used for all well completion activities where technically feasible.

Threatened and Endangered Plants

- Signage will be placed to limit off-road travel in sensitive areas.
- Buffers of 300 ft minimum between the edge of the ROW or surface disturbance and *Sclerocactus* plants will be implemented.
- Designs will avoid concentrating water flows or sentiments into occupied Sclerocactus habitats.
- Produced oil, water, or condensate tanks will be placed in centralized locations, away from occupied Sclerocactus habitat.
- A qualified biological monitor will be present during construction and drilling activities to ensure that documented Sclerocactus are not disturbed.
- Newfield will perform ground disturbing activities in *Sclerocactus* Core Conservation Areas (CCAs) outside of the flowering period (April 1 through May 30)
- Only water (no chemicals, reclaimed production water or oil filed brine) will be used for dust abatement measures within *Sclerocactus* habitat.
- Dust abatement will be employed in suitable *Sclerocactus* habitat over the life of the project during the time of the year when *Sclerocactus* species are most vulnerable to dust-related impacts (march through August) within *Sclerocactus* habitat.
- The seed mix would be amended to exclude Siberian wheatgrass and Snake River wheatgrass for reclamation seeding on this project.

Page 5 of 10 Well: GMBU M-29-8-17 10/22/2015

• Erosion control measures (i.e. silt fencing) would be implemented to minimize sedimentation to *Sclerocactus* plants and populations located downslope of proposed surface disturbing activities when working in all *Sclerocactus* habitat.

- Application for Pesticide Use Permit would include provisions for mechanical removal as opposed to chemical removal, for utah Class A, B, and C, noxious weeds within 50 feet of individual/populations of Sclerocactus.
- From one year of the date forward of 100 percent Sclerocactus clearance survey for this project, spot checks will be conducted and approved for all planned disturbance areas on an annual basis. Results of spot checks may require additional pre-construction plant surveys as directed by the BLM. If the proposed action or parts thereof have not occurred within four years of the original survey, 100 percent clearance re-survey would be required prior to ground-disturbing activities.
- Newfield commits to compensate for the project impacts that are located within the core
 Conservation Area by contributing a monetary amount disclosed between Newfield and the
 USFWS (\$12,322.20 for 1.97 acres) to the Sclerocactus fund in an effort to aid in the recovery
 of the species (Table 1). This monetary amount must be paid to the Sclerocactus Mitigation
 Fund within 90 days upon receipt of this letter, or before construction of the Project begins. The
 payment should be made to:

Sclerocactus Mitigation Fund Michelle Olson, Manager, Impact-Directed Environmental Accounts National Fish and Wildlife Foundation 1133 Fifteenth Street NW, Suite 1100 Washington, DC 20005

Page 6 of 10 Well: GMBU M-29-8-17 10/22/2015

DOWNHOLE PROGRAM CONDITIONS OF APPROVAL (COAs)

SITE SPECIFIC DOWNHOLE COAs:

 Newfield Production Co. shall adhere to all referenced requirements in the SOP (version: "Greater Monument Butte Green River Development Program", Feb 16, 2012). The operator shall also comply with applicable laws and regulations; with lease terms Onshore Oil and Gas Orders, NTL's; and with other orders and instructions of the, authorized officer.

All provisions outlined in Onshore Oil & Gas Order #2 Drilling Operations shall be strictly adhered to. The following items are emphasized:

DRILLING/COMPLETION/PRODUCING OPERATING STANDARDS

- The spud date and time shall be reported orally to Vernal Field Office within 24 hours of spudding.
- Notify Vernal Field Office Supervisory Petroleum Engineering Technician at least 24 hours in advance of casing cementing operations and BOPE & casing pressure tests.
- All requirements listed in Onshore Order #2 III. E. Special Drilling Operations are applicable for air drilling of surface hole.
- Blowout prevention equipment (BOPE) shall remain in use until the well is completed or abandoned. Closing unit controls shall remain unobstructed and readily accessible at all times. Choke manifolds shall be located outside of the rig substructure.
- All BOPE components shall be inspected daily and those inspections shall be recorded in the
 daily drilling report. Components shall be operated and tested as required by Onshore Oil &
 Gas Order No. 2 to insure good mechanical working order. All BOPE pressure tests shall be
 performed by a test pump with a chart recorder and <u>NOT</u> by the rig pumps. Test shall be
 reported in the driller's log.
- BOP drills shall be initially conducted by each drilling crew within 24 hours of drilling out from under the surface casing and weekly thereafter as specified in Onshore Oil & Gas Order No. 2.
- Casing pressure tests are required before drilling out from under all casing strings set and cemented in place.
- No aggressive/fresh hard-banded drill pipe shall be used within casing.
- Cement baskets shall not be run on surface casing.
- The operator must report all shows of water or water-bearing sands to the BLM. If flowing water
 is encountered it must be sampled, analyzed, and a copy of the analyses submitted to the BLM
 Vernal Field Office.

Page 7 of 10 Well: GMBU M-29-8-17 10/22/2015

- The operator must report encounters of all non oil & gas mineral resources (such as Gilsonite, tar sands, oil shale, trona, etc.) to the Vernal Field Office, in writing, within 5 working days of each encounter. Each report shall include the well name/number, well location, date and depth (from KB or GL) of encounter, vertical footage of the encounter and, the name of the person making the report (along with a telephone number) should the BLM need to obtain additional information.
- A complete set of angular deviation and directional surveys of a directional well will be submitted to the Vernal BLM office engineer within 30 days of the completion of the well.
- While actively drilling, chronologic drilling progress reports shall be filed directly with the BLM,
 Vernal Field Office on a weekly basis in sundry, letter format or e-mail to the Petroleum
 Engineers until the well is completed.
- A cement bond log (CBL) will be run from the production casing shoe to the <u>top of cement</u> and shall be utilized to determine the bond quality for the production casing. Submit a field copy of the CBL to this office.
- Please submit an electronic copy of all other logs run on this well by CD (compact disc).
 This submission will supersede the requirement for submittal of paper logs to the BLM.
- There shall be no deviation from the proposed drilling, completion, and/or workover program as approved. Safe drilling and operating practices must be observed. Any changes in operation must have prior approval from the BLM Vernal Field Office.

Page 8 of 10 Well: GMBU M-29-8-17 10/22/2015

OPERATING REQUIREMENT REMINDERS:

 All wells, whether drilling, producing, suspended, or abandoned, shall be identified in accordance with 43 CFR 3162.6. There shall be a sign or marker with the name of the operator, lease serial number, well number, and surveyed description of the well.

- For information regarding production reporting, contact the Office of Natural Resources Revenue (ONRR) at www.ONRR.gov.
- In accordance with 43 CFR 3162.4-3, this well shall be reported on the "Monthly Report of Operations" (Oil and Gas Operations Report ((OGOR)) starting with the month in which operations commence and continue each month until the well is physically plugged and abandoned. This report shall be filed in duplicate, directly with the Minerals Management Service, P.O. Box 17110, Denver, Colorado 80217-0110, or call 1-800-525-7922 (303) 231-3650 for reporting information.
- Should the well be successfully completed for production, the BLM Vernal Field office must be
 notified when it is placed in a producing status. Such notification will be by written
 communication and must be received in this office by not later than the fifth business day
 following the date on which the well is placed on production. The notification shall provide, as a
 minimum, the following informational items:
 - o Operator name, address, and telephone number.
 - Well name and number.
 - Well location (¼¼, Sec., Twn, Rng, and P.M.).
 - Date well was placed in a producing status (date of first production for which royalty will be paid).
 - o The nature of the well's production, (i.e., crude oil, or crude oil and casing head gas, or natural gas and entrained liquid hydrocarbons).
 - o The Federal or Indian lease prefix and number on which the well is located; otherwise the non-Federal or non-Indian land category, i.e., State or private.
 - Unit agreement and/or participating area name and number, if applicable.
 - o Communitization agreement number, if applicable.
- Any venting or flaring of gas shall be done in accordance with Notice to Lessees (NTL) 4A and needs prior approval from the BLM Vernal Field Office.
- All undesirable events (fires, accidents, blowouts, spills, discharges) as specified in NTL 3A will be reported to the BLM, Vernal Field Office. Major events, as defined in NTL3A, shall be reported verbally within 24 hours, followed by a written report within 15 days. "Other than Major Events" will be reported in writing within 15 days. "Minor Events" will be reported on the Monthly Report of Operations and Production.
- Whether the well is completed as a dry hole or as a producer, "Well Completion and

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Recompletion Report and Log" (BLM Form 3160-4) shall be submitted not later than 30 days after completion of the well or after completion of operations being performed, in accordance with 43 CFR 3162.4-1. Two copies of all logs run, core descriptions, and all other surveys or data obtained and compiled during the drilling, workover, and/or completion operations, shall be filed on BLM Form 3160-4. Submit with the well completion report a geologic report including, at a minimum, formation tops, and a summary and conclusions. Also include deviation surveys, sample descriptions, strip logs, core data, drill stem test data, and results of production tests if performed. Samples (cuttings, fluid, and/or gas) shall be submitted only when requested by the BLM, Vernal Field Office.

- All off-lease storage, off-lease measurement, or commingling on-lease or off-lease, shall have prior written approval from the BLM Vernal Field Office.
- Oil and gas meters shall be calibrated in place prior to any deliveries. The BLM Vernal Field
 Office Petroleum Engineers will be provided with a date and time for the initial meter calibration
 and all future meter proving schedules. A copy of the meter calibration reports shall be
 submitted to the BLM Vernal Field Office. All measurement facilities will conform to the API
 standards for liquid hydrocarbons and the AGA standards for natural gas measurement. All
 measurement points shall be identified as the point of sale or allocation for royalty purposes.
- A schematic facilities diagram as required by Onshore Oil & Gas Order No. 3 shall be submitted
 to the BLM Vernal Field Office within 30 days of installation or first production, whichever occurs
 first. All site security regulations as specified in Onshore Oil & Gas Order No. 3 shall be
 adhered to. All product lines entering and leaving hydrocarbon storage tanks will be effectively
 sealed in accordance with Onshore Oil & Gas Order No. 3.
- Any additional construction, reconstruction, or alterations of facilities, including roads, gathering
 lines, batteries, etc., which will result in the disturbance of new ground, shall require the filing of
 a suitable plan and need prior approval of the BLM Vernal Field Office. Emergency approval
 may be obtained orally, but such approval does not waive the written report requirement.
- No location shall be constructed or moved, no well shall be plugged, and no drilling or workover
 equipment shall be removed from a well to be placed in a suspended status without prior
 approval of the BLM Vernal Field Office. If operations are to be suspended for more than 30
 days, prior approval of the BLM Vernal Field Office shall be obtained and notification given
 before resumption of operations.
- Pursuant to Onshore Oil & Gas Order No. 7, this is authorization for pit disposal of water produced from this well for a period of 90 days from the date of initial production. A permanent disposal method must be approved by this office and in operation prior to the end of this 90-day period. In order to meet this deadline, an application for the proposed permanent disposal method shall be submitted along with any necessary water analyses, as soon as possible, but no later than 45 days after the date of first production. Any method of disposal which has not been approved prior to the end of the authorized 90-day period will be considered as an Incident of Noncompliance and will be grounds for issuing a shut-in order until an acceptable manner for disposing of said water is provided and approved by this office.
- Unless the plugging is to take place immediately upon receipt of oral approval, the Field Office
 Petroleum Engineers must be notified at least 24 hours in advance of the plugging of the well, in
 order that a representative may witness plugging operations. If a well is suspended or
 abandoned, all pits must be fenced immediately until they are backfilled. The "Subsequent

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Report of Abandonment" (Form BLM 3160-5) must be submitted within 30 days after the actual plugging of the well bore, showing location of plugs, amount of cement in each, and amount of casing left in hole, and the current status of the surface restoration.

Sundry Number: 72363 API Well Number: 43013530070000

	FORM 9			
STATE OF UTAH DEPARTMENT OF NATURAL RESOURCES DIVISION OF OIL, GAS, AND MINING			5.LEASE DESIGNATION AND SERIAL NUMBER: UTU-76956	
SUNDRY NOTICES AND REPORTS ON WELLS			6. IF INDIAN, ALLOTTEE OR TRIBE NAME:	
Do not use this form for proposals to drill new wells, significantly deepen existing wells below current bottom-hole depth, reenter plugged wells, or to drill horizontal laterals. Use APPLICATION FOR PERMIT TO DRILL form for such proposals.			7.UNIT or CA AGREEMENT NAME: GMBU (GRRV)	
1. TYPE OF WELL Oil Well			8. WELL NAME and NUMBER: GMBU M-29-8-17	
2. NAME OF OPERATOR: NEWFIELD PRODUCTION COMPANY			9. API NUMBER: 43013530070000	
3. ADDRESS OF OPERATOR: Rt 3 Box 3630 , Myton, UT, 84052 435 646-4825 Ext			9. FIELD and POOL or WILDCAT: MONUMENT BUTTE	
4. LOCATION OF WELL FOOTAGES AT SURFACE: 1994 FNL 1959 FEL			COUNTY: DUCHESNE	
QTR/QTR, SECTION, TOWNSHIP, RANGE, MERIDIAN: Qtr/Qtr: SWNE Section: 29 Township: 08.0S Range: 17.0E Meridian: S			STATE: UTAH	
11. CHECK APPROPRIATE BOXES TO INDICATE NATURE OF NOTICE, REPORT, OR OTHER DATA				
TYPE OF SUBMISSION				
/	ACIDIZE	ALTER CASING	CASING REPAIR	
NOTICE OF INTENT Approximate date work will start: 7/1/2016	CHANGE TO PREVIOUS PLANS	CHANGE TUBING	CHANGE WELL NAME	
7/1/2010	CHANGE WELL STATUS	COMMINGLE PRODUCING FORMATIONS	CONVERT WELL TYPE	
SUBSEQUENT REPORT Date of Work Completion:	DEEPEN	FRACTURE TREAT	NEW CONSTRUCTION	
Date of Work Completion.	OPERATOR CHANGE	PLUG AND ABANDON	PLUG BACK	
	PRODUCTION START OR RESUME	RECLAMATION OF WELL SITE	RECOMPLETE DIFFERENT FORMATION	
SPUD REPORT Date of Spud:	REPERFORATE CURRENT FORMATION	SIDETRACK TO REPAIR WELL	TEMPORARY ABANDON	
	TUBING REPAIR	VENT OR FLARE	WATER DISPOSAL	
DRILLING REPORT	WATER SHUTOFF	SI TA STATUS EXTENSION	✓ APD EXTENSION	
Report Date:	WILDCAT WELL DETERMINATION	OTHER	OTHER:	
12 DESCRIBE PROPOSED OR		I nertinent details including dates	denths volumes etc	
12. DESCRIBE PROPOSED OR COMPLETED OPERATIONS. Clearly show all pertinent details including dates, depths, volumes, etc. Newfield proposes to extend the Application for Permit to Drill this well. Approved by the Utume Disis 2016 f Oil, Gas and Mining				
			Date:	
			By: Loggill	
NAME (PLEASE PRINT)	PHONE NUMBE	R TITLE		
Mandie Crozier	435 646-4825	Regulatory Tech		
SIGNATURE N/A		DATE 6/13/2016		

Sundry Number: 72363 API Well Number: 43013530070000



The Utah Division of Oil, Gas, and Mining

- State of Utah
- Department of Natural Resources

Electronic Permitting System - Sundry Notices

Title: Regulatory Tech Representing: NEWFIELD PRODUCTION COMPANY

Request for Permit Extension Validation Well Number 43013530070000

API: 43013530070000 **Well Name:** GMBU M-29-8-17

Location: 1994 FNL 1959 FEL QTR SWNE SEC 29 TWNP 080S RNG 170E MER S

Company Permit Issued to: NEWFIELD PRODUCTION COMPANY

Date Original Permit Issued: 7/1/2014

The undersigned as owner with legal rights to drill on the property as permitted above, hereby verifies that the information as submitted in the previously approved application to drill, remains valid and does not require revision. Following is a checklist of some items related to the application, which should be verified.

• If located on private land, has the ownership changed, if so, has the surface agreement been updated? Yes No
Have any wells been drilled in the vicinity of the proposed well which would affect the spacing or siting requirements for this location? Yes No
• Has there been any unit or other agreements put in place that could affect the permitting or operation of this proposed well? Yes No
• Have there been any changes to the access route including ownership, or rightof- way, which could affect the proposed location? Yes No
• Has the approved source of water for drilling changed? Yes No
 Have there been any physical changes to the surface location or access route which will require a change in plans from what was discussed at the onsite evaluation? Yes No
• Is bonding still in place, which covers this proposed well? Yes No
nature: Mandie Crozier Date: 6/13/2016